

City of Appleton

100 North Appleton Street Appleton, WI 54911-4799 www.appleton.org

Meeting Agenda - Final Board of Building Inspection

Thursday, October 18, 2018

3:00 PM

Council Chambers, 6th Floor

- 1. Call meeting to order
- 2. Roll call of membership
- 3. Approval of minutes from previous meeting

<u>18-1496</u> Minutes from July 3, 2018

Attachments: Meeting Minutes 7-3-18.pdf

4. Public Hearings/Appearances

5. Action Items

<u>18-1497</u>

122 E. College Ave. (31-2-0282-02) The applicant proposes to maintain an exit path that is 116 feet. Table 1006.2.1 of IBC 2015 limits travel paths to 100 feet for business occupancies with sprinklers.

Attachments: 122 E. College Ave.pdf

122 E. College Ave(plan).pdf

6. Information Items

7. Adjournment

Notice is hereby given that a quorum of the Common Council may be present during this meeting, although no Council action will be taken.

Reasonable Accommodations for Persons with Disabilities will be made upon Request and if Feasible.



City of Appleton

100 North Appleton Street Appleton, WI 54911-4799 www.appleton.org

Meeting Minutes - Final Board of Building Inspection

Tuesday, July 3, 2018

10:00 AM

Council Chambers, 6th Floor

- 1. Call meeting to order
- 2. Roll call of membership

Present: 4 - Public Works Director Vandehey, Behrens, Hanna and Strauss

Approval of minutes from previous meeting

18-0963

Minutes from November 20, 2017.

Attachments:

Minutes for 11-20-17.pdf

Public Works Director Vandehey moved, seconded by Behrens, that the Minutes be approved. Roll Call. Motion carried by the following vote:

Aye: 4 - Public Works Director Vandehey, Behrens, Hanna and Strauss

- 4. Public Hearings/Appearances
- 5. Action Items

18-0962

4321 N. Ballard Road (31-1-6451-00) The applicant is proposing to provide an automatic notification alarm in lieu of meeting the code standards in Section 713.5 of the International Building Code related to continuity of a shaft. *Include a requirement to sprinkle the penthouse area and close all openings as pratical.*

Attachments:

4321 N Ballard Rd (31-1-6451-00).pdf

Public Works Director Vandehey moved, seconded by Behrens, that the Report Action Item be approved as amended. Roll Call. Motion carried by the following vote:

Aye: 4 - Public Works Director Vandehey, Behrens, Hanna and Strauss

- 6. Information Items
- 7. Adjournment

Public Works Director Vandehey moved, seconded by Behrens, that the meeting be adjourned. Roll Call. Motion carried by the following vote:


Aye: 4 - Public Works Director Vandehey, Behrens, Hanna and Strauss

Return to:

Department of Public Works

Inspection Division 100 North Appleton Street Appleton, Wisconsin 54911

(920) 832-6411

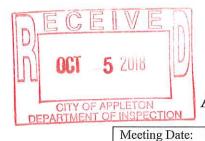

City of Appleton Application for Board of Building Inspection


Please write legibly and also submit a complete reproducible plan (maximum size 11" x 17"). A

	Property Information
Address of Property (Variance Reque	ested) Parcel Number
221 E. College Ave	= = =
Zoning District	Use Residential X Commerci
CBD	
	Applicant Information
Owner Name	Owner Address
Washington Street Real Estate	200 E. Washington St.
Investment Fund	Appleton, WI 54911
Owner Phone Number	Owner E Mail address (optional)
920-560-5068	toms@naipfefferle.com
Agent Name	Agent Address
	200 E. Washington St.
Tom Scheuerman	Appleton, WI 54911
Agent Phone Number	Agent E Mail address (optional)
920-560-5068	toms@naipfefferle.com
	Variance Information
Municipal Code Section(s) Project Do	
IBC 2015 Table 1006.2.1 Spaces with	
Occupancy B - With Sprinkler System	- 100 feet
Maximum common path of travel dista	ance will be 116 feet which exceeds code requirement
16 feet.	
Brief Description of Proposed Project	
	e proposed suite, and (2) additional smoke detectors
public corridor.	II.
Will maintain the existing fire alarm p	oull station at the suite entrance.

ANTS SERVED

EXIT

BUSINESS
5120 S.F. / 100
TOTAL OCCUPANTS BASED ON AREA: 52 PEOPLE
TOTAL OCCUPANTS ACTUAL <49 PEOPLE
49 x .2 = 9.8" EXIT WIDTH REQUIRED
34" PROVIDED

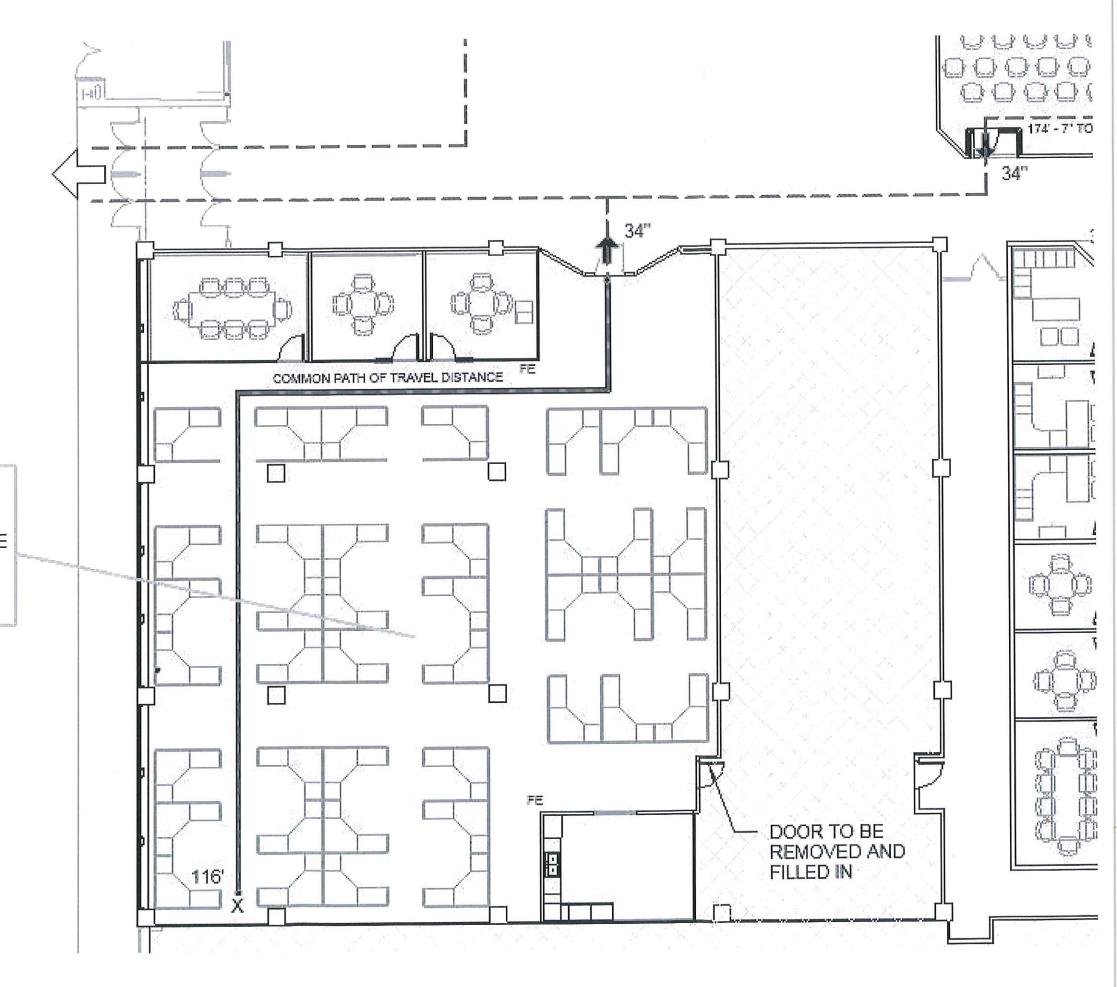

FION





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920,380,2800


BID DOCUMENTS

EAST 1E

CITY CENTER I

6944 2018 LBG KWB

SEH FILE NO. ISSUE DATE DESIGN BY DRAWN BY PROJECT MGF

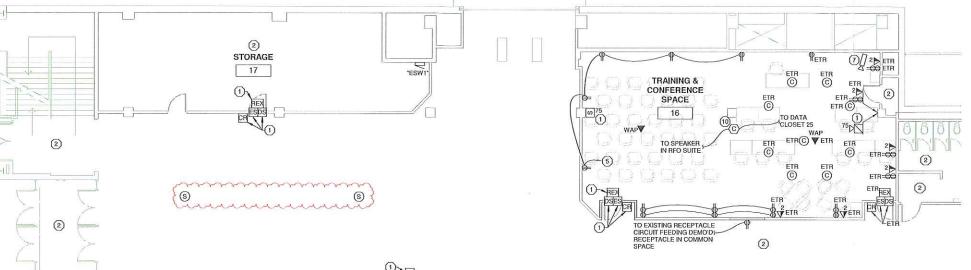

TO SPEAKER IN TRAINING & CONFERENCE SPACE 16

2

OFFICE (3)2

13

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FTR-O

100

BREAK ROOM 15

"X" _ 20/V1P ETR ETR 4

HUDDLE ROOM

3 12

GENERAL NOTES:

- CONFIRM EXACT LOCATION OF ALL OUTLETS AND CONNECTIONS WITH OWNER'S FURNITURE LAYOUT PRIOR TO ROUGH-IN.
- ALL RECEPTACLES MOUNTED WITHIN 6 FEET OF SINKS SHALL BE GFI TYPE.
- ALL LOW VOLTAGE CABLING IN AREAS WITH EXPOSED STRUCTURE SHALL BE IN CONDUIT.

- EXISTING DEVICE REINSTALLED FROM WHERE INDICATED ON DEMO PLAN.

- CONNECT TO EXISTING CIRCUIT FEEDING DEMO'D ITEMS IN AREA.
- CONNECT RELOCATED ELECTRIC RADIANT CEILING PANEL (ERCP) TO EXISTING CIRCUIT FEEDING EXISTING. EXTEND EXISTING CIRCUIT AS REQUIRED.

- MOUNT IN FACE OF CEILING TILE, VERIFY EXACT LOCATION WITH OWNER PRIOR TO ROUGH-IN.

ROUTE ALL DATA, PAGING, ACCESS CONTROL, AND DURESS SYSTEM CABLING TO DATA CLOSET 25 IN CREDIT UNION SUITE. ALL CABLING ROUTED OUTSIDE OF RFO SUITE AND CREDIT UNION SUITE SHALL BE IN EMT CONDUIT. ROUTE THRU COMMON SPACE; DO NOT CROSS OTHER TENANT SPACES.

PLAN NOTES:(X)

NO NEW DEVICES.

MOUNT IN SAME LOCATION AS REMOVED DATA JACK; SEE DEMO PLAN FOR ADDITIONAL INFORMATION.

PROVIDE POWER AND DATA CONNECTION TO FURNITURE. INSTALL WHIP SUPPLIED WITH FURNITURE TO EXTEND POWER FROM WALL TO FURNITURE, EXTEND LOW VOLTAGE CABLING INTO FURNITURE RACEWAY AND MOUNT DEVICES IN FURNITURE, COORDINATE EXACT LOCATION OF ROUGH-IN WITH FURNITURE VENDOR.

PROVIDE (1) CAT6+ DATA CABLE WITH 5' COIL ABOVE CEILING TERMINATED ON JACK AND TESTED. THRIVENT TO PROVIDE CAMERA AND PATCH CABLES.

VERIFY EXACT WORKSTATION WITH OWNER PRIOR TO ROUGH-IN, FEED THRU FURNITURE AND MOUNT UNDER DESKTOP.

INSTALL AND TERMINATE SPEAKER (FBO). PROVIDE 2#18 PLENUM RATED CABLING BETWEEN SPEAKERS AND RACK MOUNTED AMPLIFIER IN DATA CLOSET 25, THRIVENT TO PROVIDE SPEAKERS, PLENUM COVERS, GRILLE COVERS, AND AMPLIFIER. TERMINATE HOMERUN AT AMPLIFIER.

1 RFO SUITE FLOOR PLAN - POWER 1/8" = 1'-0"

CONFERENCE

ROOM

11

41)4

®ERCP

® ERCP

O=ETR

4₃**4**

®ERCF

3 4

© ERCP ETR

(3)

RFO SUITE POWER

E102P