BUILDING REMODEL FOR:

PARKER JOHN'S

APPLETON, WISCONSIN



2637 Tulip Lane Green Bay, WI 54313 Phone: (920) 469-9288 Fax: (920) 469-6809 E-mail: Info@IntegrityEngineering.biz

INTEGRITY MISSION STATEMENT

WE PROVIDE HIGH QUALITY ARCHITECTURAL DESIGN AND STRUCTURAL ENGINEERING. OUR PLANS MOVE SMOOTHLY THROUGH THE STATE REVIEW PROCESS AND MAKE BUILDING CONSTRUCTION MORE ENJOYABLE. OUR SERVICE IS UNMATCHED AND OUR INTEGRITY IS IMPECCABLE.

IF YOU HAVE ANY QUESTIONS OR COMMENTS ABOUT THE CONTENT OR PRESENTATION OF MATERIAL ON THIS PLAN, PLEASE CALL (920) 469-9288

GENERAL CONDITIONS:

THESE PLANS ARE PRESENTED TO LEAD A HIGH QUALITY DESIGN/BUILD TEAM. EACH CONTRACTOR AND SUBCONTRACTOR IS RESPONSIBLE TO PROVIDE EXCELLENT DESIGN, BUILDING MATERIALS, AND CRAFTSMANSHIP WHICH WE CAN ALL BE PROUD OF. WE ENCOURAGE YOU TO PROVIDE EXPERTISE IN YOUR CHOSEN FIELD AND TO BRING IDEAS AND CONCERNS TO THE ATTENTION OF THE GENERAL

THESE DRAWINGS COVER STRUCTURAL AND GENERAL CONSTRUCTION ONLY. ALL WORK SHALL CONFORM TO STANDARD PRACTICES AND APPLICABLE LAWS, WHETHER THEY ARE SPECIFICALLY STATED IN THESE PLANS OR NOT.

EACH CONTRACTOR SHALL:

-VISIT THE SITE TO VERIFY EXISTING CONDITIONS, ACCESS, ETC. PRIOR TO

-MAINTAIN A CLEAN JOB SITE AT ALL TIMES. -OBTAIN AND PAY FOR PERMITS, LICENSES, FEES, ETC. AS MAY BE REQUIRED

FOR COMPLETION OF HIS OWN PORTION OF THE PROJECT. -FIELD VERIFY DIMENSIONS.

-REPORT ANY DISCREPANCY NOTED BETWEEN THESE PLANS AND APPLICABLE CODES TO THE GENERAL CONTRACTOR.

-PROVIDE ALL BARRIERS, FENCES, SAFETY EQUIPMENT AND PRECAUTIONS REQUIRED BY APPLICABLE LAWS AND STANDARD PRACTICES.

ALL MATERIALS SHALL BE INSTALLED PER MANUFACTURERS REQUIREMENTS AND RECOMMENDATIONS.

ANY HAZARDOUS MATERIALS ENCOUNTERED DURING DEMOLITION, REMODELING, OR EXCAVATION SHALL BE REMOVED AND/OR CONTAINED IN ACCORDANCE WITH GOVERNING LOCAL, STATE, AND FEDERAL REGULATIONS.


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QUICK SPEC

TO MAKE THIS PLAN MORE CONTRACTOR FRIENDLY, WE HAVE PREPARED IT WITH OUR QUICK SPEC SYSTEM.

THE WRITTEN SPEC IS GENERAL AND DOES NOT GO INTO DEPTH TO REITERATE STANDARD PRACTICES OR APPLICABLE LAWS. IT IS WRITTEN IN AN EASY TO READ FORMAT. THE SPECIFICATION IS SPLIT INTO APPROPRIATE SECTIONS AND LISTED ON THE PLAN WHERE IT IS NEEDED. YOU WILL FIND THESE SECTIONS QUICKLY BY THE SHADOW BOX AROUND IT (SIMILAR TO THIS ONE).

SPECIFIC CASES THAT CANNOT BE DESCRIBED IN A GENERAL SPEC ARE NOTED ON THE PLANS. IF THERE IS A DISCREPANCY BETWEEN THE PLAN AND THE GENERAL SPEC, THE PLAN NOTES WILL SUPERSEDE THE GENERAL SPEC.

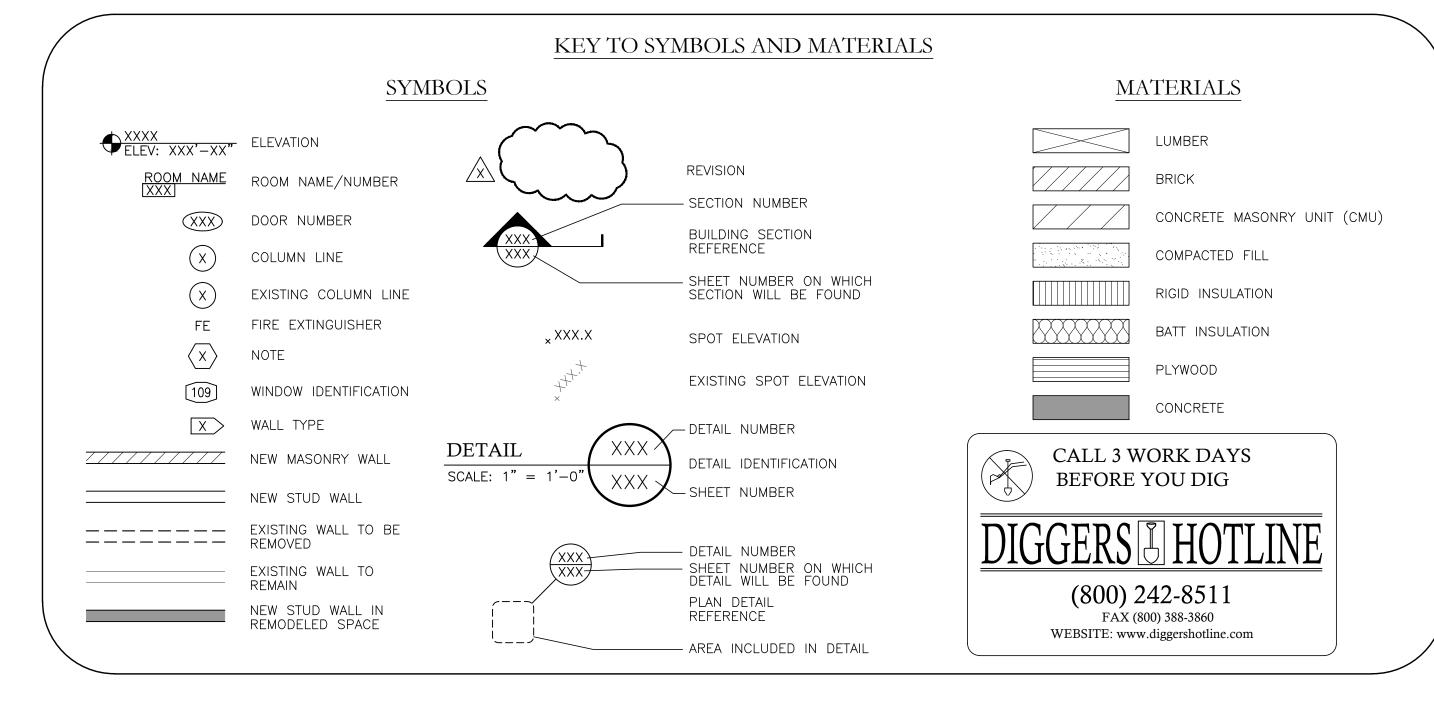

SITE LOCATION MAP



BUILDING DATA

BUILDING CODE: IBC 2015

BUILDING SIZE:

REMODELED AREA (SQ. FT.): 6,671 NEW SHED BUILDING AREA (SQ. FT.): 128 EXISTING AREA (SQ. FT.): 6,671 ALLOWABLE AREÀ PER FLOOR (SQ. FT.): EXISITNG NUMBER OF STORIES: **EXISTING** EAVE HEIGHT: MAXIMUM OVERALL HEIGHT: **EXISTING** 5,500 8'-0" SHED ALLOWABLE AREA (SQ. FT.): SHED EAVE HEIGHT:

CONSTRUCTION CLASSIFICATION:

EXISTING - TYPE VB NEW - TYPE VB

OCCUPANCY:

A-2, U (SHED, ACCESSORY OCCUPANCY)

DESIGN LOADS: PER IBC 2015, CHAPTER 16

ULTIMATE DESIGN WIND SPEED = 115 MPH WIND EXPOSURE = SEISMIC CATEGORY = SOIL BEARING PRESSURE = 2000 PSF PRESUMED

FIRE PROTECTION SYSTEMS

AUTOMATIC FIRE SPRINKLER SYSTEM - EXISTING STANDPIPE SYSTEMS - NOT REQUIRED SEE IBC 905 FIRE ALARM SYSTEM - NOT REQUIRED SMOKE DETECTORS - INSTALL PER APPLICABLE CODES EXIT SIGNS - PROVIDE EXIT SIGNS PER IBC SECTION 1013 FIRE EXTINGUISHERS - INSTALL PER NFPA 1 AND APPLICABLE LOCAL CODES

DRAWING INDEX

T1.0 COVER SHEET

T1.1 RENDERINGS

T1.2 RENDERINGS

D1.0 EXISTING/DEMO FLOOR PLAN

D2.0 EXISTING/DEMO ELEVATIONS

S1.0 FOUNDATION AT DUMPSTER ENCLOSURE

A1.0 REMODELED FLOOR PLAN

A1.1 REFLECTED CEILING PLAN AND INTERIOR ELEVATIONS


A2.0 ELEVATIONS

A3.0 SECTIONS AND SECTION DETAILS


A4.0 SCHEDULES / HEAD, JAMB, AND SILL DETAILS

THE STAMP OF INTEGRITY ENGINEERING'S SUPERVISING PROFESSIONAL ON THIS SET OF DRAWINGS IS IN NO WAY ATTESTING TO THE ACCURACY AND COMPLETENESS OF THE DRAWINGS PREPARED BY SUB-CONSULTANTS INCLUDED HEREIN. THE RESPONSIBILITY FOR THE DRAWINGS BY SUB-CONSULTANTS LIES WITH THE RESPECTIVE SUB-CONSULTANTS (CIVIL, MEPFP, ETC.) THEY ARE INCLUDED HERE FOR CONVENIENCE AND INFORMATIONAL PURPOSES ONLY.

ISSUED FOR CONSTRUCTION

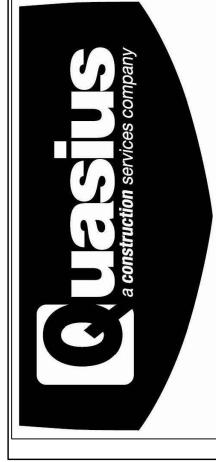



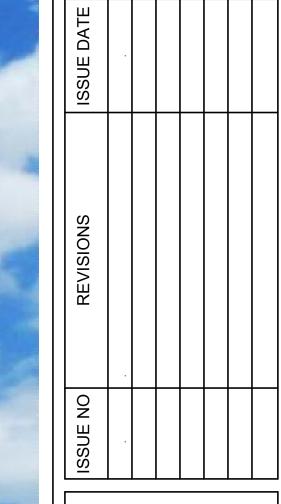

ASIUS CONSTRUCTION
PARKER JOHN'S

22145 29 August, 2022 A. WOLF K. KUEPER

> Project number Date Drawn by Checked by

T1.1








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REVISIONS				
ISSUE NO	•			


BUILDING REMODEL FOR:
QUASIUS CONSTRUCTION
PARKER JOHN'S
2331 E. EVERGREEN DR.


22145 9 August, 2022 A. WOLF K. KUEPER


Project number Date Drawn by Checked by

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QUASIUS CONSTRUCT
PARKER JOHN'S

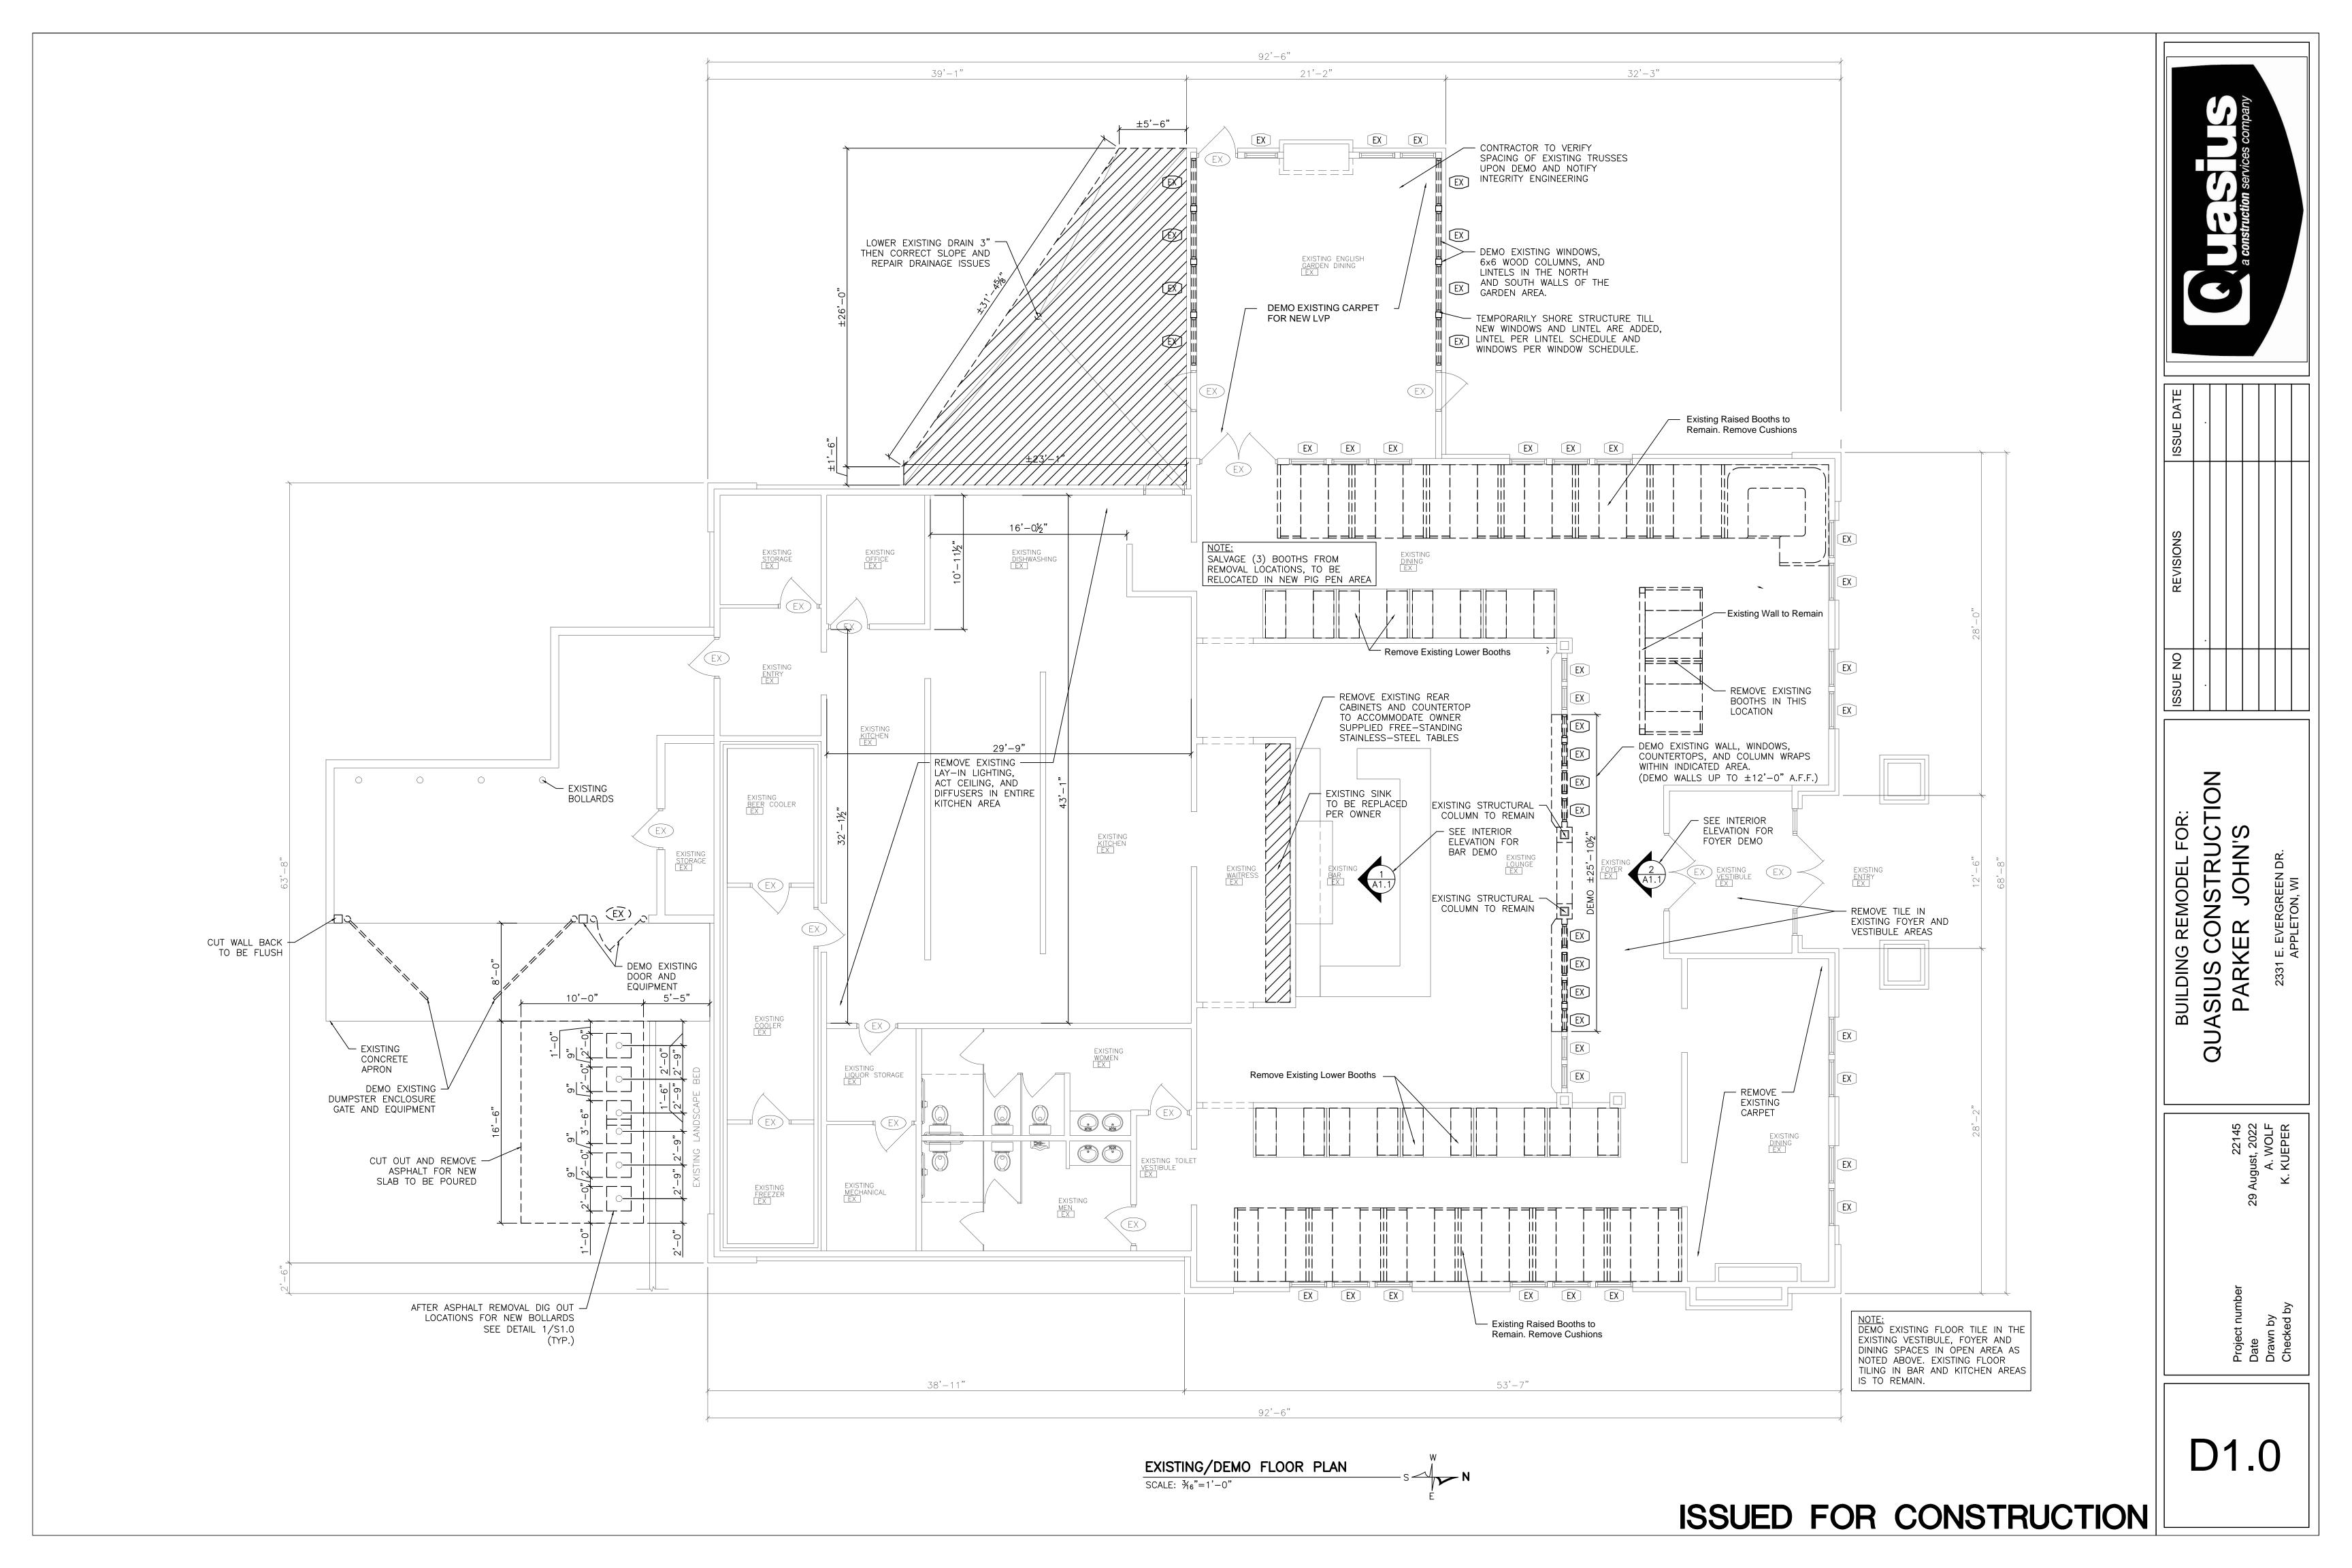22145 29 August, 2022 A. WOLF K. KUEPER

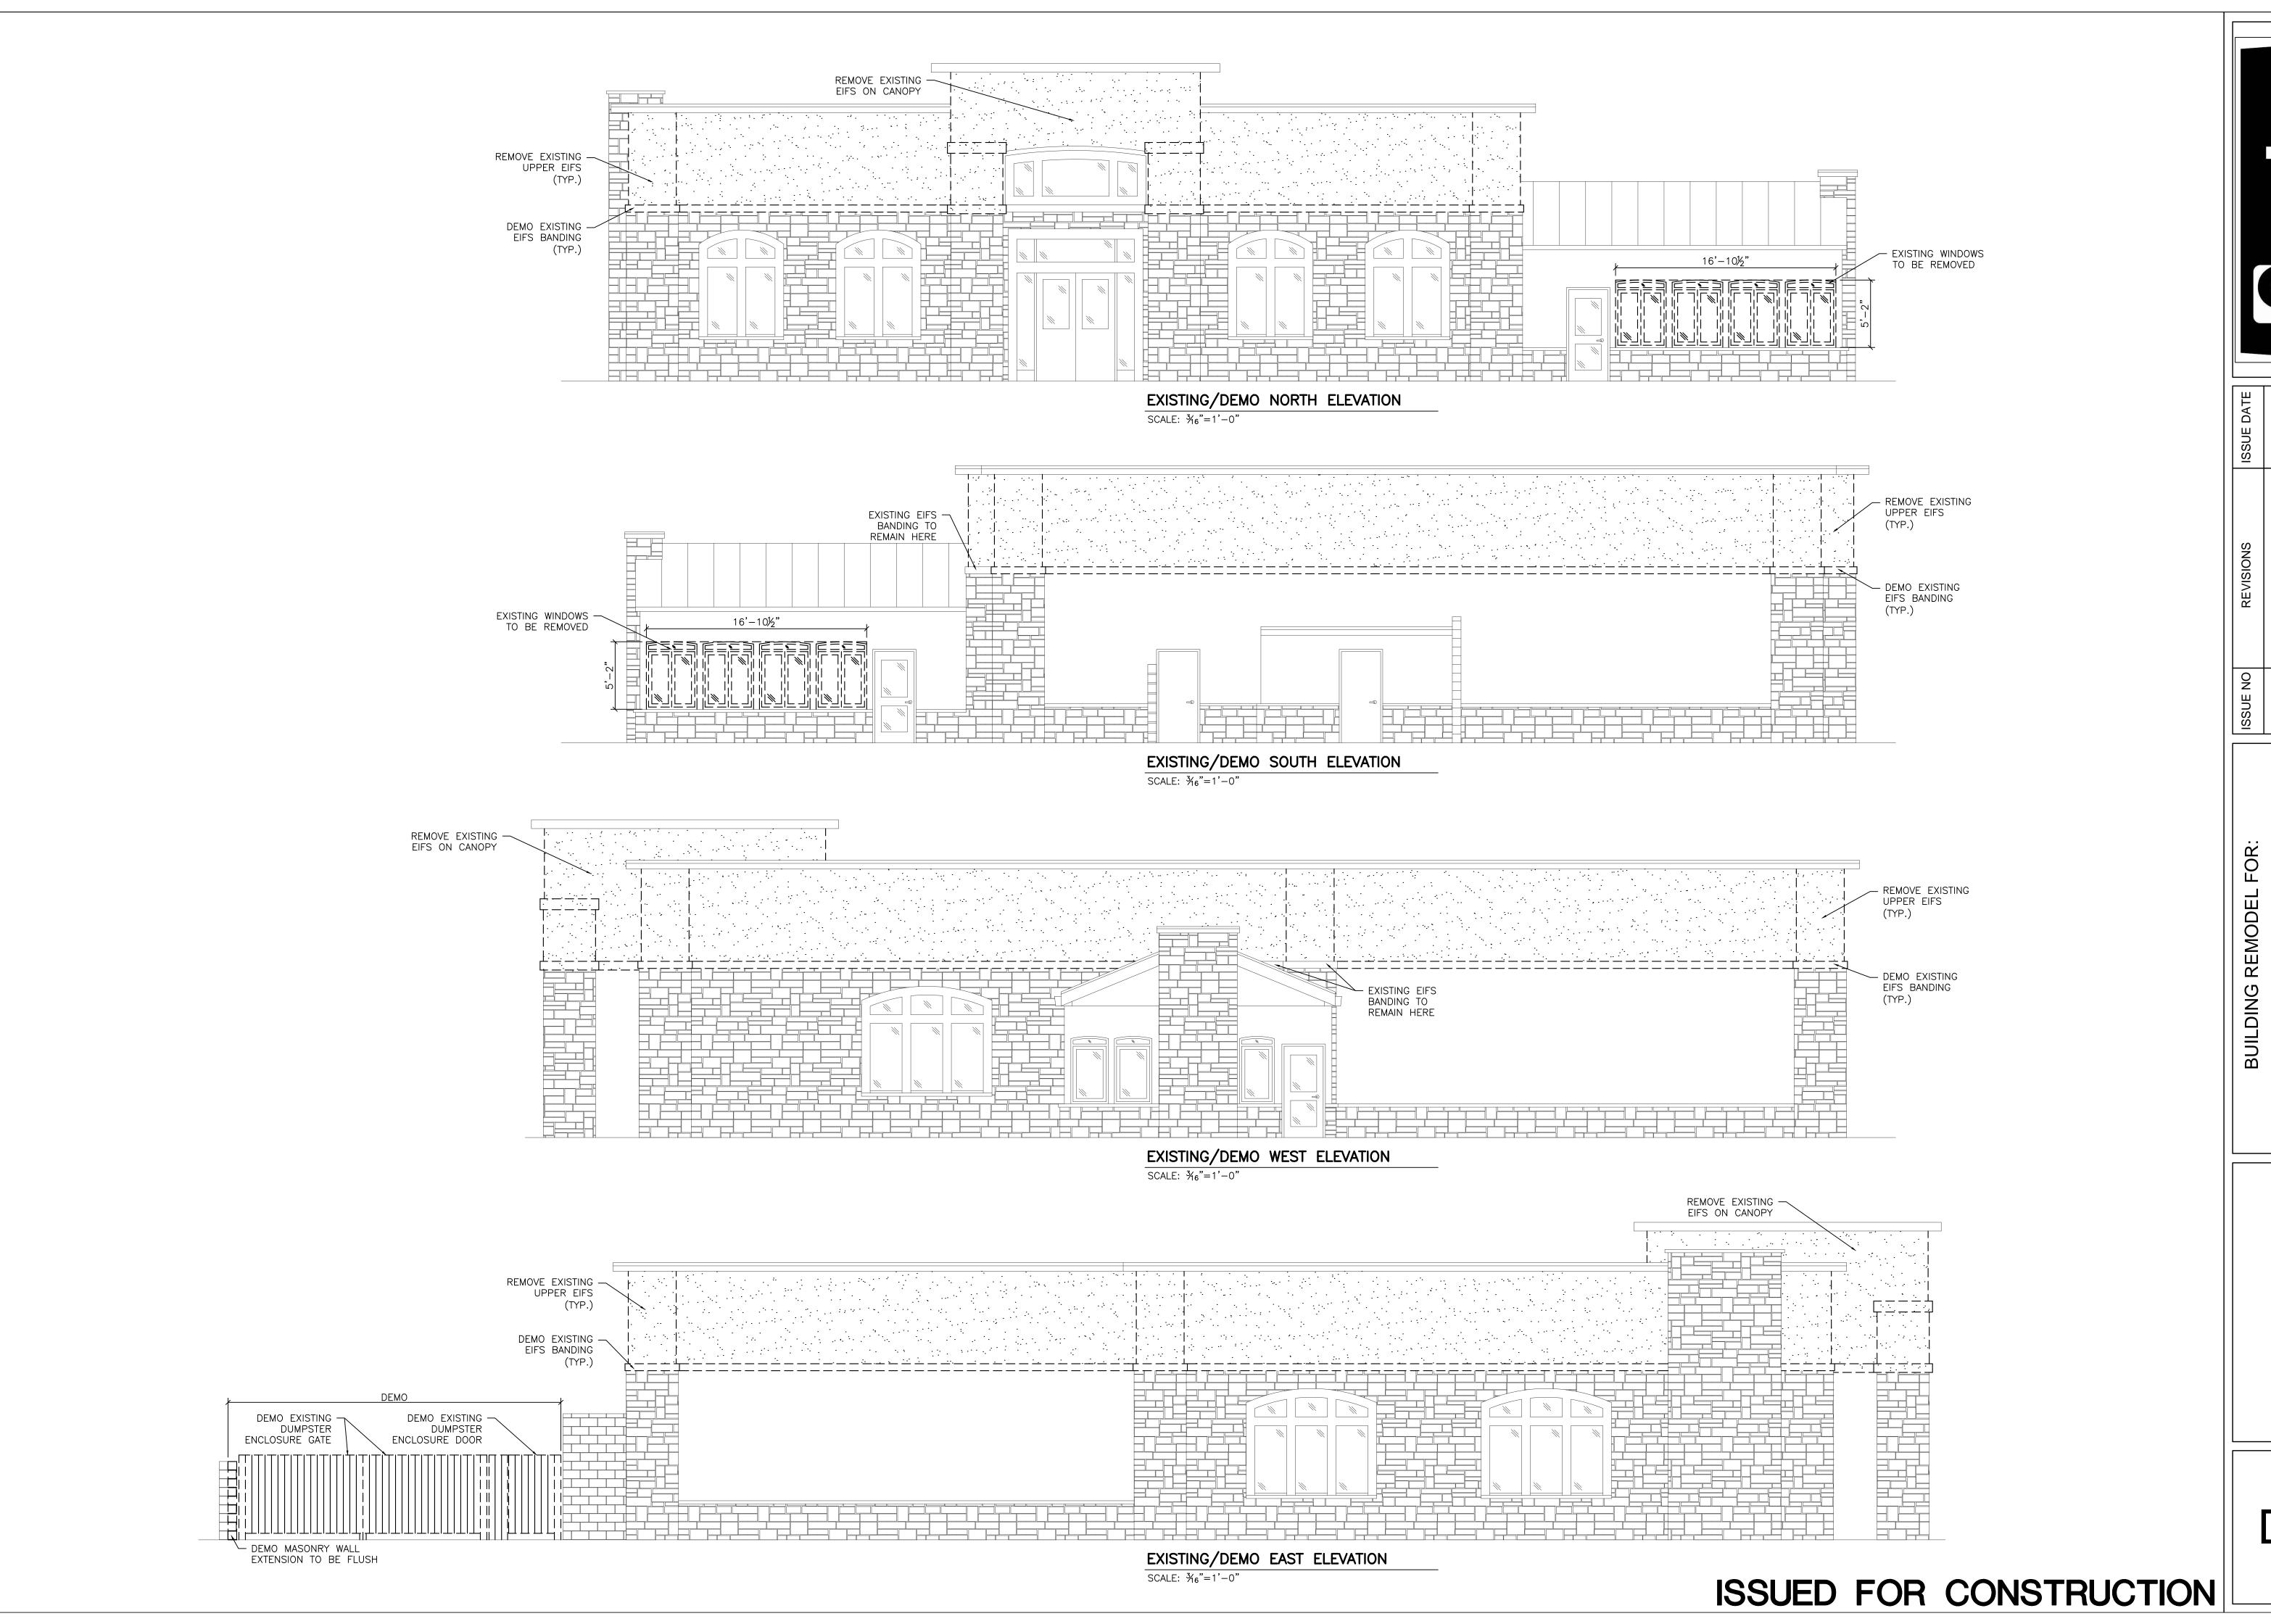Project number
Date
Drawn by

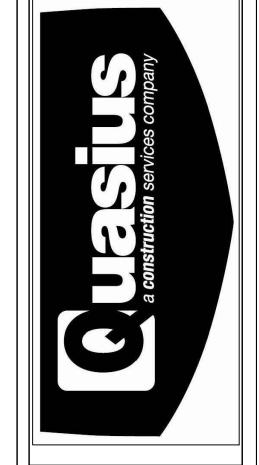D2.0

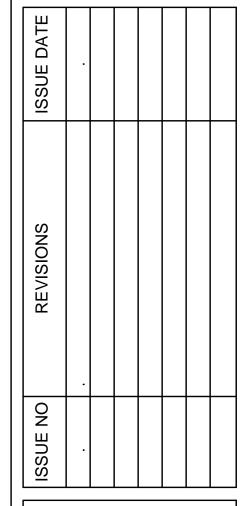CONCRETE CONTRACTOR SHALL VERIFY SOIL CONDITIONS BEFORE PLACING FOUNDATIONS AND SLABS. NOTIFY THE GENERAL CONTRACTOR IF ANY SOIL CONDITIONS APPEAR OUT OF THE ORDINARY.

FOOTINGS SHALL BEAR ON UNDISTURBED SOIL OR STRUCTURAL FILL. DO NOT PLACE FOOTINGS ON FROZEN GROUND.

- DESIGN MIXES SHALL BE IN ACCORDANCE WITH ASTM C94. 1) FOOTINGS AND WALLS SHALL HAVE STRENGTH EQUAL TO 3,000 PSI AT 28 DAYS.
 2) SLABS ON GRADE SHALL HAVE STRENGTH EQUAL TO 4,000 PSI AT 28 DAYS
- 4) COLUMNS, BEAMS AND STRUCTURAL SLABS SHALL HAVE STRENGTH EQUAL TO 4,000 PSI AT 28 DAYS 5) PRE CAST TOPPING SHALL HAVE STRENGTH EQUAL TO 4000 PSI AT 28 DAYS. 6) SLUMP SHALL NOT EXCEED 4". 7) ALL CONCRETE EXPOSED TO WEATHER SHALL BE AIR—ENTRAINED WITH 4-7%
 AIR CONTENT. NO OTHER ADMIXTURES SHALL BE USED WITHOUT THE APPROVAL
 OF THE GENERAL CONTRACTOR. CALCIUM CHLORIDE SHALL NOT BE USED.

 8) MAXIMUM AGGREGATE SIZE FOR FOOTING TO BE 1 1/2" AND MAXIMUM AGGREGATE

3) EXTERIOR CONCRETE SHALL HAVE STRENGTH EQUAL TO 4,000 PSI AT 28 DAYS.

- SIZE FOR ALL OTHER WORK TO BE 3/4". PLACE FLOOR SLABS WITH CONSTRUCTION JOINTS OR SAW JOINTS NOT EXCEEDING A MAXIMUM OF 156 SQUARE FEET OR AS INDICATED ON THE PLANS. SAW CUTTING TO BE DONE AS SOON AS POSSIBLE, BUT NO LATER THAN 24 HOURS AFTER CONCRETE IS PLACED.
- INTERIOR SLABS TO HAVE A TROWEL FINISH AND EXTERIOR SLABS TO HAVE A LIGHT BROOM FINISH. MAINTAIN FLOOR LEVEL AT WALLS AND PITCH SURFACES UNIFORMLY TO DRAINS.
 CONCRETE TO BE SEALED OR WET CURED FOR 7 DAYS. FLOORS TO RECEIVE TILE OR EPOXY
 TO BE WET CURED ONLY. EXTERIOR SLABS SHALL BE SEPARATED FROM BUILDINGS WITH CONTINUOUS 1/2" FIBER EXPANSION JOINT.
- DESIGN AND CONSTRUCTION OF CAST-IN-PLACE CONCRETE SHALL CONFORM TO ACI 318 AND CRSI STANDARDS.

ANCHOR BOLTS AND THREADED RODS TO BE ASTM F1554. MINIMUM GRADE A36.

REINFORCING STEEL

REINFORCING STEEL TO CONFORM TO ASTM-A615, GRADE 60. WELDED WIRE FABRIC SHALL CONFORM TO ASTM-A185. LAP ALL HORIZONTAL REINFORCING AT SPLICES AND AROUND CONFORM TO ASIM—A185. LAP ALL HORIZONTAL REINFORCING AT SPLICES AND AROUND CORNERS 30 BAR DIAMETERS. WELDED WIRE FABRIC IS TO BE LAPPED 6" AND PLACED IN THE CENTER OF THE SLAB UNLESS INDICATED OTHERWISE. REINFORCING SHALL BE PLACED IN CONFORMANCE WITH CRSI "RECOMMENDED PRACTICES FOR PLACING BARS" AND ACI 318. THE REINFORCEMENT SHALL NOT BE PAINTED AND MUST BE FREE OF GREASE, DIRT OR DEEP RUST WHEN PLACED. PROVIDE CONCRETE PROTECTION FOR REBARS PER ACI 318 SECTION 7.7.

THE SITE WORK CONTRACTOR IS REQUIRED TO CONTACT DIGGER'S HOTLINE. ALL UTILITIES SHALL BE LOCATED PRIOR TO STARTING EXCAVATION.

ALL EXCAVATION AND BACK FILL FOR MECHANICALS ARE THE RESPONSIBILITY OF THE RESPECTIVE MECHANICAL CONTRACTOR. THESE TRENCHES ARE TO BE FILLED IN 8" LIFTS AND COMPACTED TO 95% OF THE MODIFIED PROCTOR VALUE. ENSURE TRENCH ROUTE IS CLEAR OF UTILITIES AND OTHER OBSTRUCTIONS PRIOR TO DIGGING.

THE EXCAVATION CONTRACTOR SHALL ADVISE THE GENERAL CONTRACTOR OF ANY SOIL CONDITIONS WHICH APPEAR OUT OF THE ORDINARY. THE SOIL BEARING CAPACITY IS LISTED ON THE COVER SHEET.

ALL ORGANIC TOPSOIL INSIDE THE BUILDING AREA, UNDER PAVED AREAS AND AT SITE FILL AREAS SHALL BE REMOVED. CONTRACTOR SHALL VERIFY TOPSOIL DEPTHS PRIOR TO CONSTRUCTION.

ALL SUB GRADE FILL UNDER PAVED AREAS AND BUILDING AREAS SHALL BE CLEAN GRANULAR FILL CONFORMING TO GRADE 1 OR 2 OF SECTION 209 WDOT STANDARD. PLACE IN 8" MAXIMUM LIFTS AND COMPACT TO 95% OF THE MODIFIED PROCTOR VALUE. GRAVEL BASE BENEATH FLOOR SLABS SHALL BE 6 INCHES OF 3/4" CRUSHED STONE OR SAND COMPACTED TO THE ABOVE STANDARD. GRAVEL BASE BENEATH DRIVES, PARKING AREAS, AND APRONS SHALL BE 12" OF COMPACTED CRUSHED STONE. TYPAR SHALL BE INSTALLED WHENEVER THIS 12" BASE RESTS ON CLAY OR LOOSE SOILS. FILL SHALL NOT BE PLACED ON FROZEN GROUND AND NO FROZEN MATERIALS MAY BE USED FOR BACKFILL.

FOUNDATION TRENCHES MUST BE BACK FILLED UNIFORMLY ON EACH SIDE WITH SAND. PLACE FILL IN 8" LIFTS AND COMPACT TO 95% OF THE MODIFIED PROCTOR VALUE. THE EXTERIOR SIDE MAY BE FILLED WITH COMPACTED NON-STRUCTURAL FILL IF THERE WILL NEVER BE A PARKING LOT OR ADDITION ON THAT SIDE. WHEN IN DOUBT, BACK FILL WITH SAND. THE BUILDING SITE SHALL BE GRADED TO PROVIDE DRAINAGE AWAY FROM THE BUILDING AT A MINIMUM OF 2% SLOPE FOR 20'-0" AWAY FROM THE BUILDING, STARTING AT 5" BELOW THE FLOOR LINE OR AS INDICATED ON THE PLANS. PROVIDE 6" OF TOPSOIL AT ALL GRASS AND


SPLASH BLOCKS ARE TO BE PLACED AT ALL DOWN SPOUTS WHICH DISCHARGE AT GRADE AND IF A CURRENT GEOTECHNICAL REPORT OR PLANS BY A CIVIL CONSULTANT ARE AVAILABLE, ALL REQUIREMENTS OF THAT REPORT AND PLANS MUST BE FOLLOWED. WHEN THE


STRUCTURAL/ARCHITECTURAL PLANS OR THE INFORMATION ABOVE CONFLICT WITH THE GEOTECHNICAL REPORT OR THE CIVIL PLANS, THE INFORMATION IN THE GEOTECHNICAL REPORT AND CIVIL PLANS SUPERCEDE.


LANDSCAPED AREAS AND GRADE TO +/- 0.10 FEET.


ALL UTILITIES SHALL BE INSTALLED PER INDUSTRY STANDARDS. WATER, SANITARY AND STORM SEWER SHALL BE INSTALLED PER "STANDARD SPECIFICATION FOR SEWER AND WATER CONSTRUCTION IN WISCONSIN". THE GENERAL CONTRACTOR SHALL BE RESPONSIBLE FOR CONTACTING, APPLYING FOR, SCHEDULING AND COORDINATING THE INSTALLATION OF GAS, ELECTRIC, AND COMMUNICATION SERVICES.


LOCATIONS OF SITE UTILITIES ON THIS PLAN ARE PRELIMINARY AND MUST BE VERIFIED BY THE SITE UTILITY CONTRACTOR.

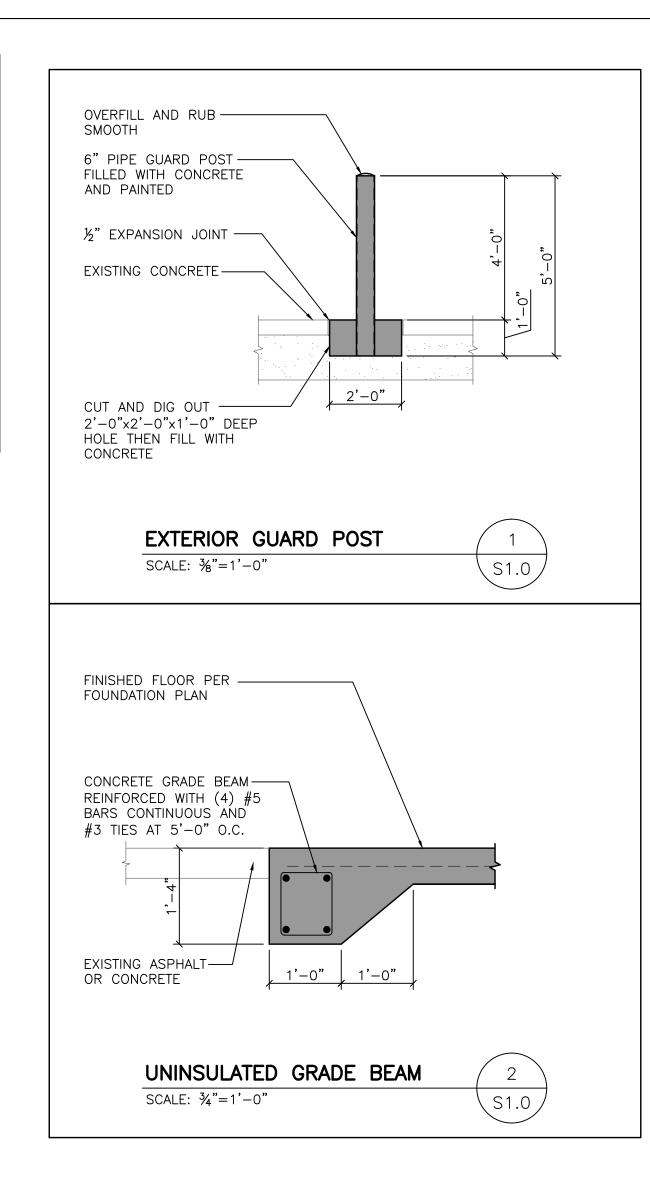


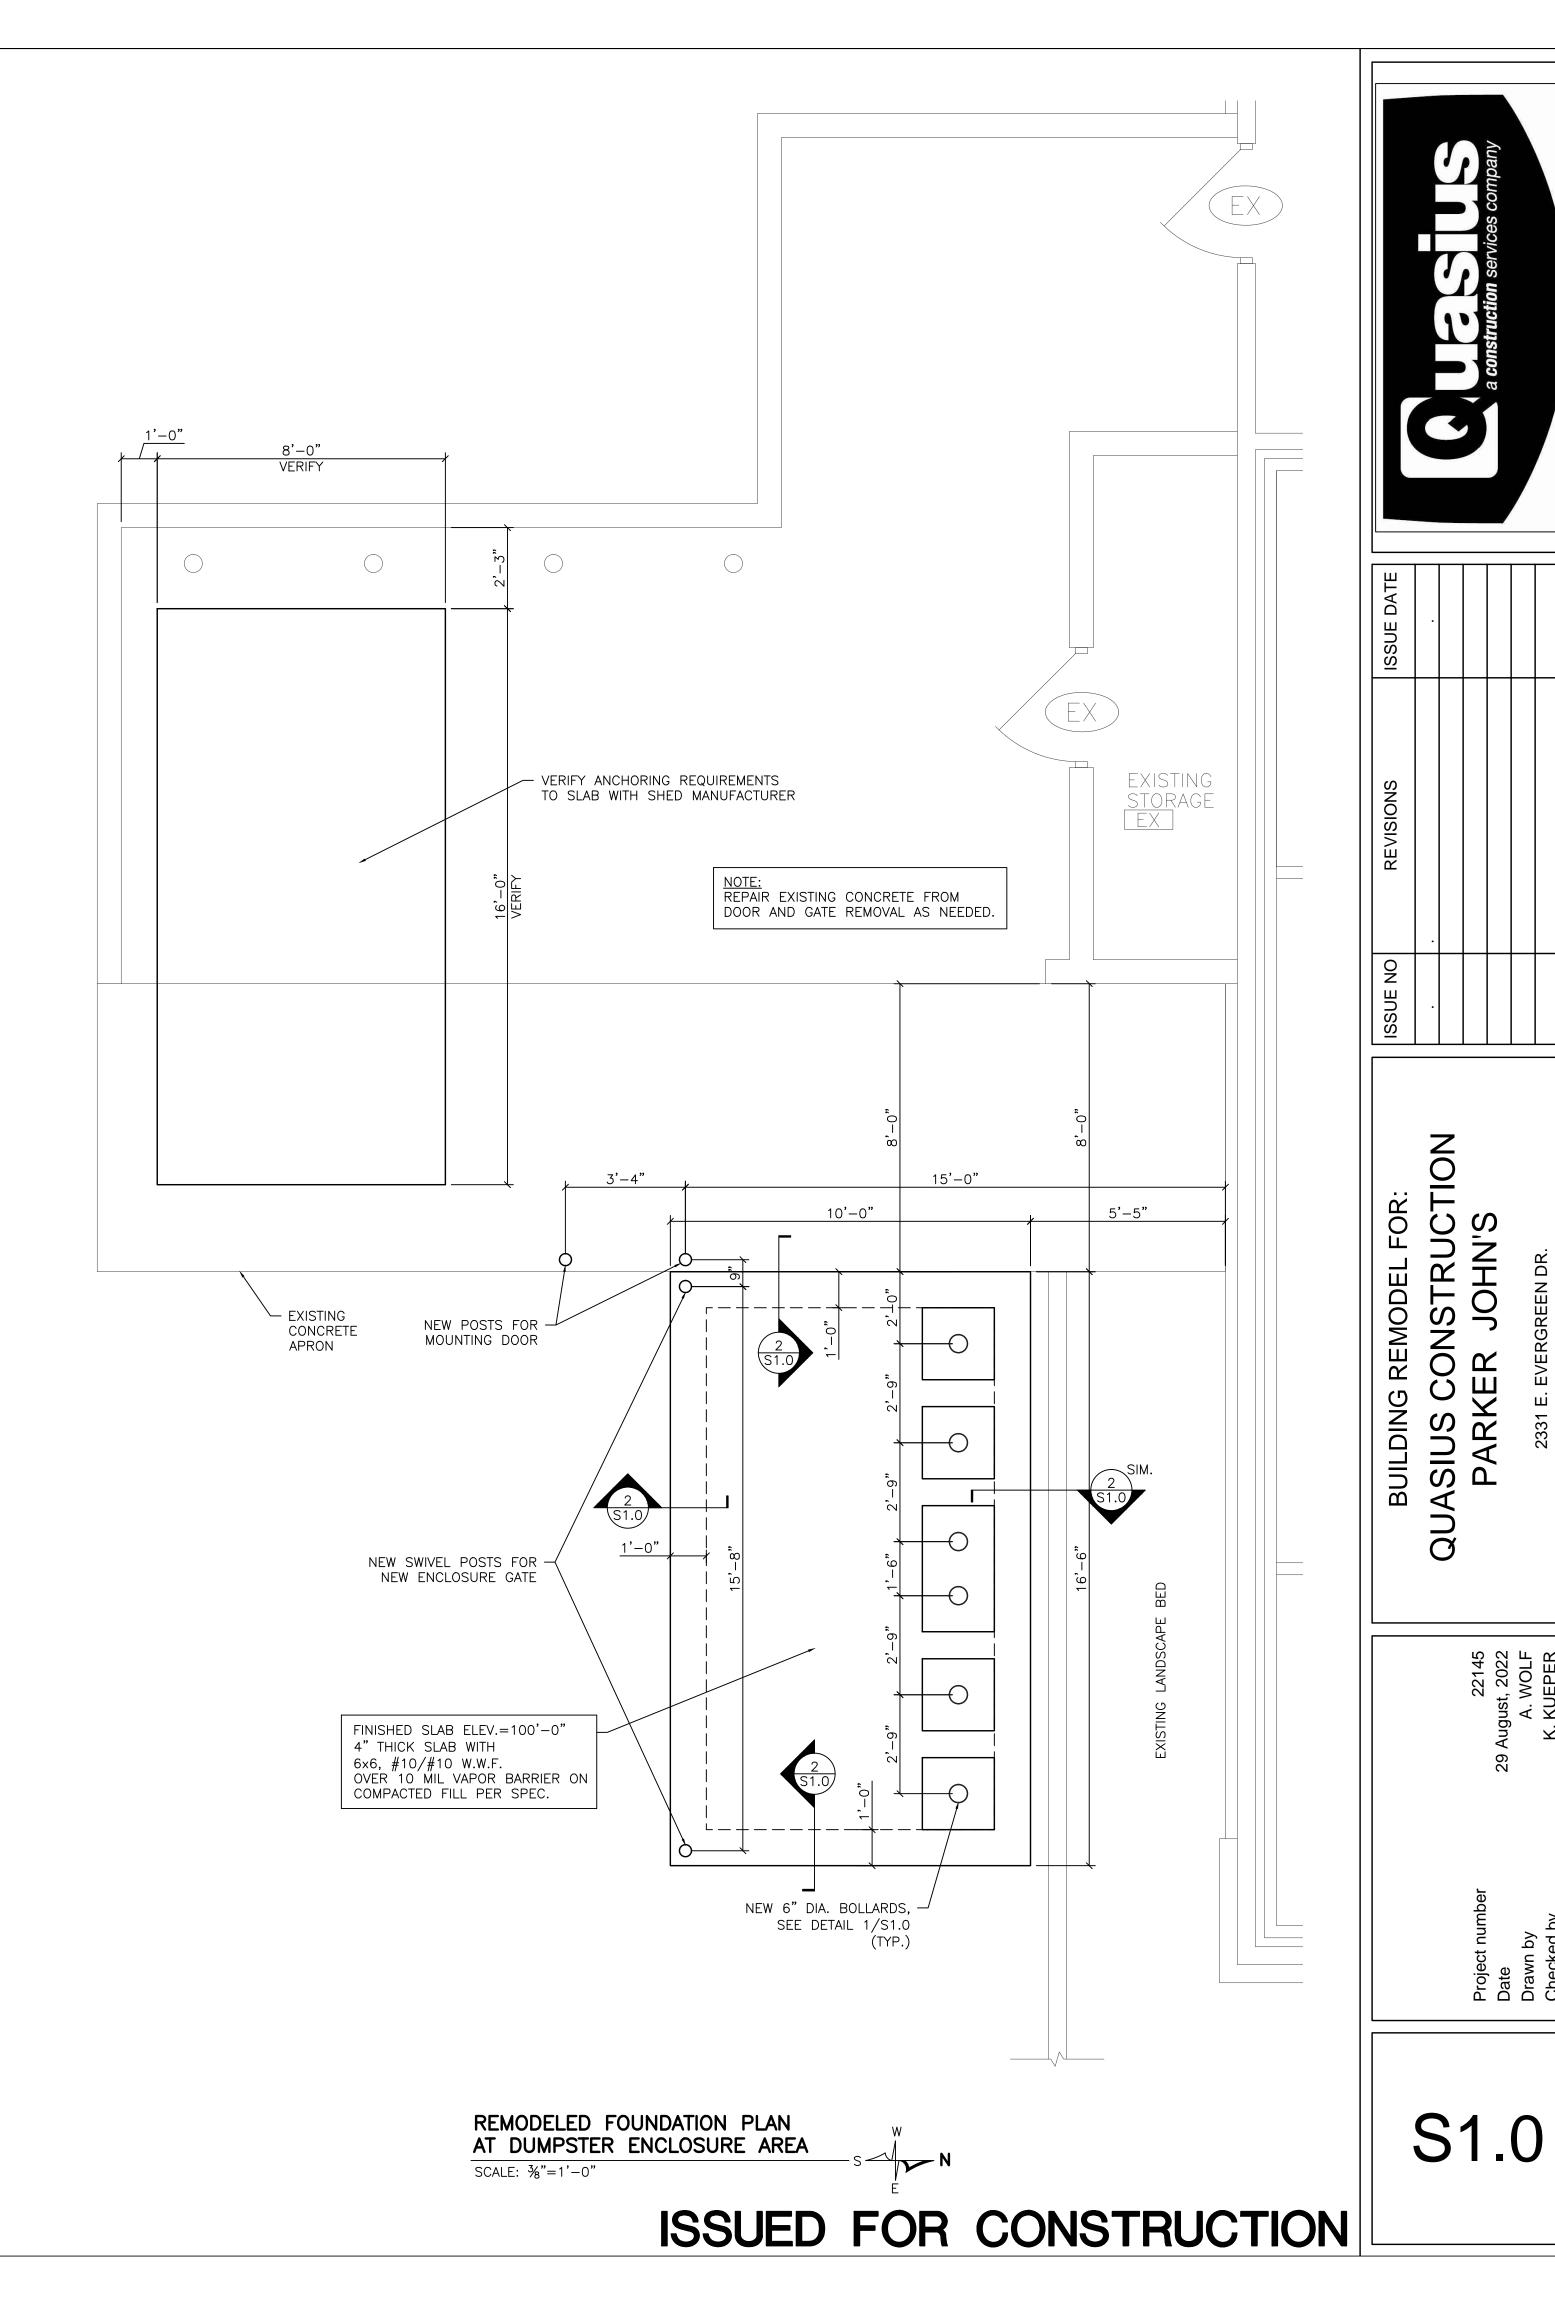


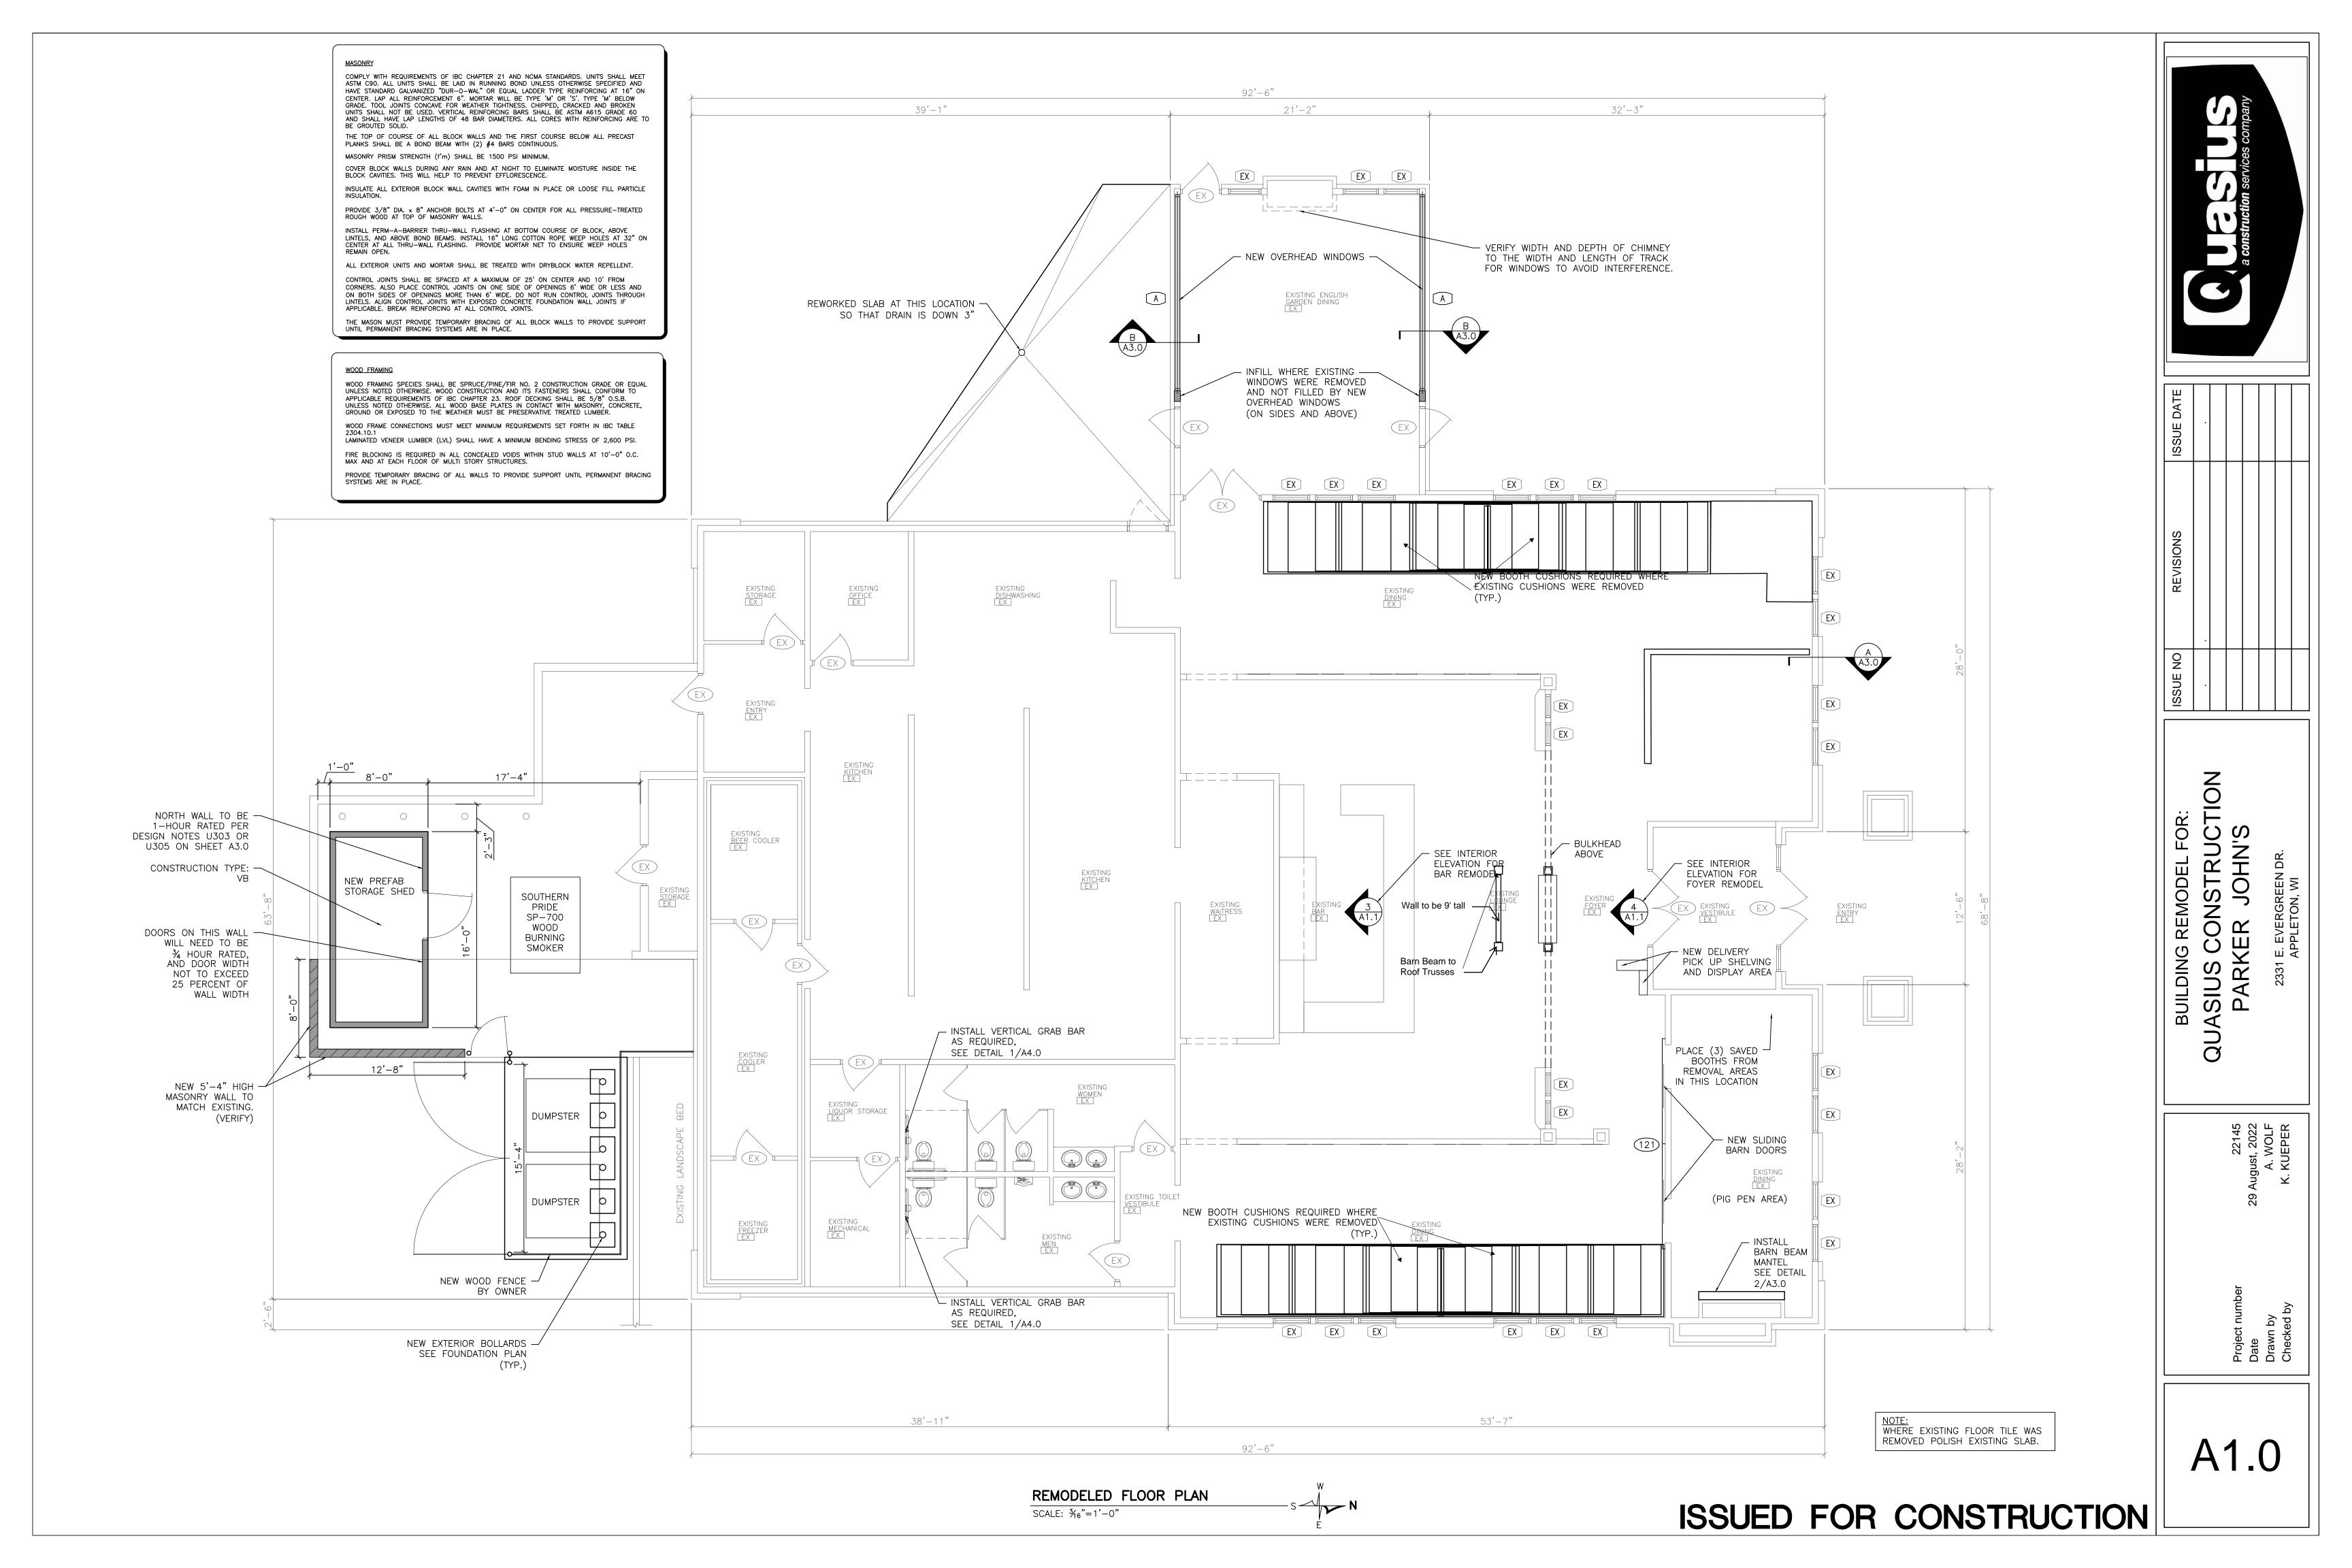

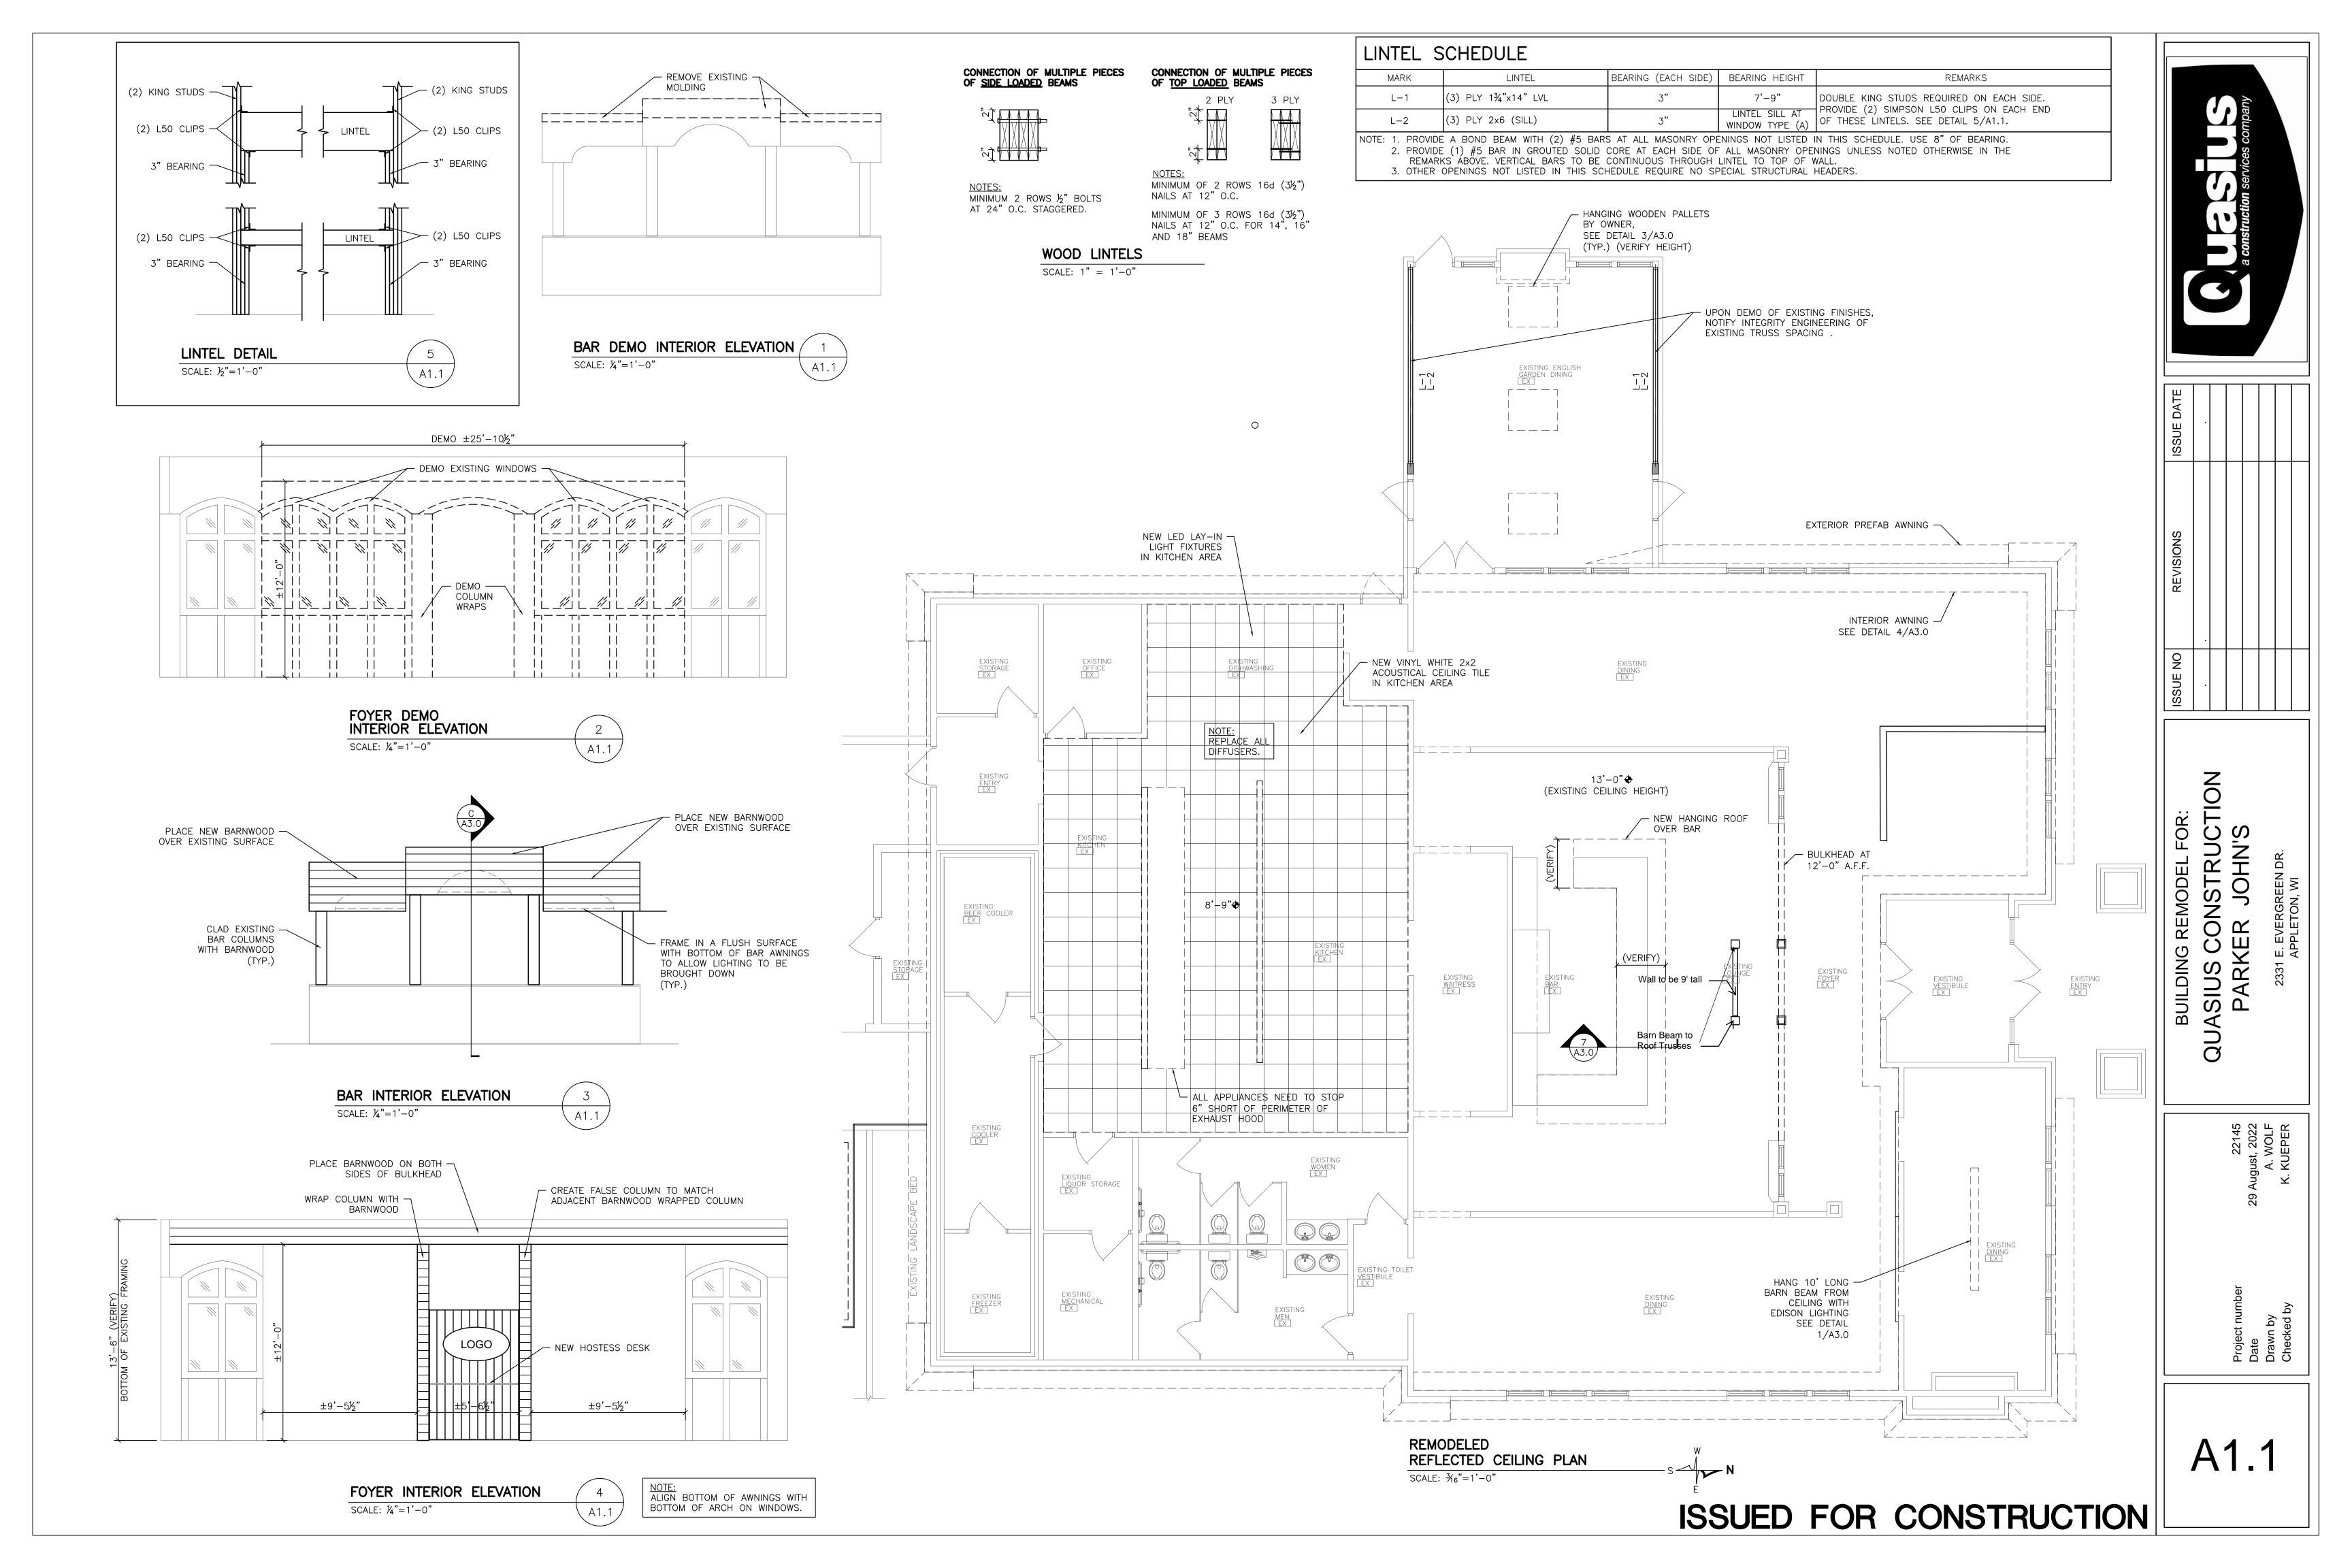

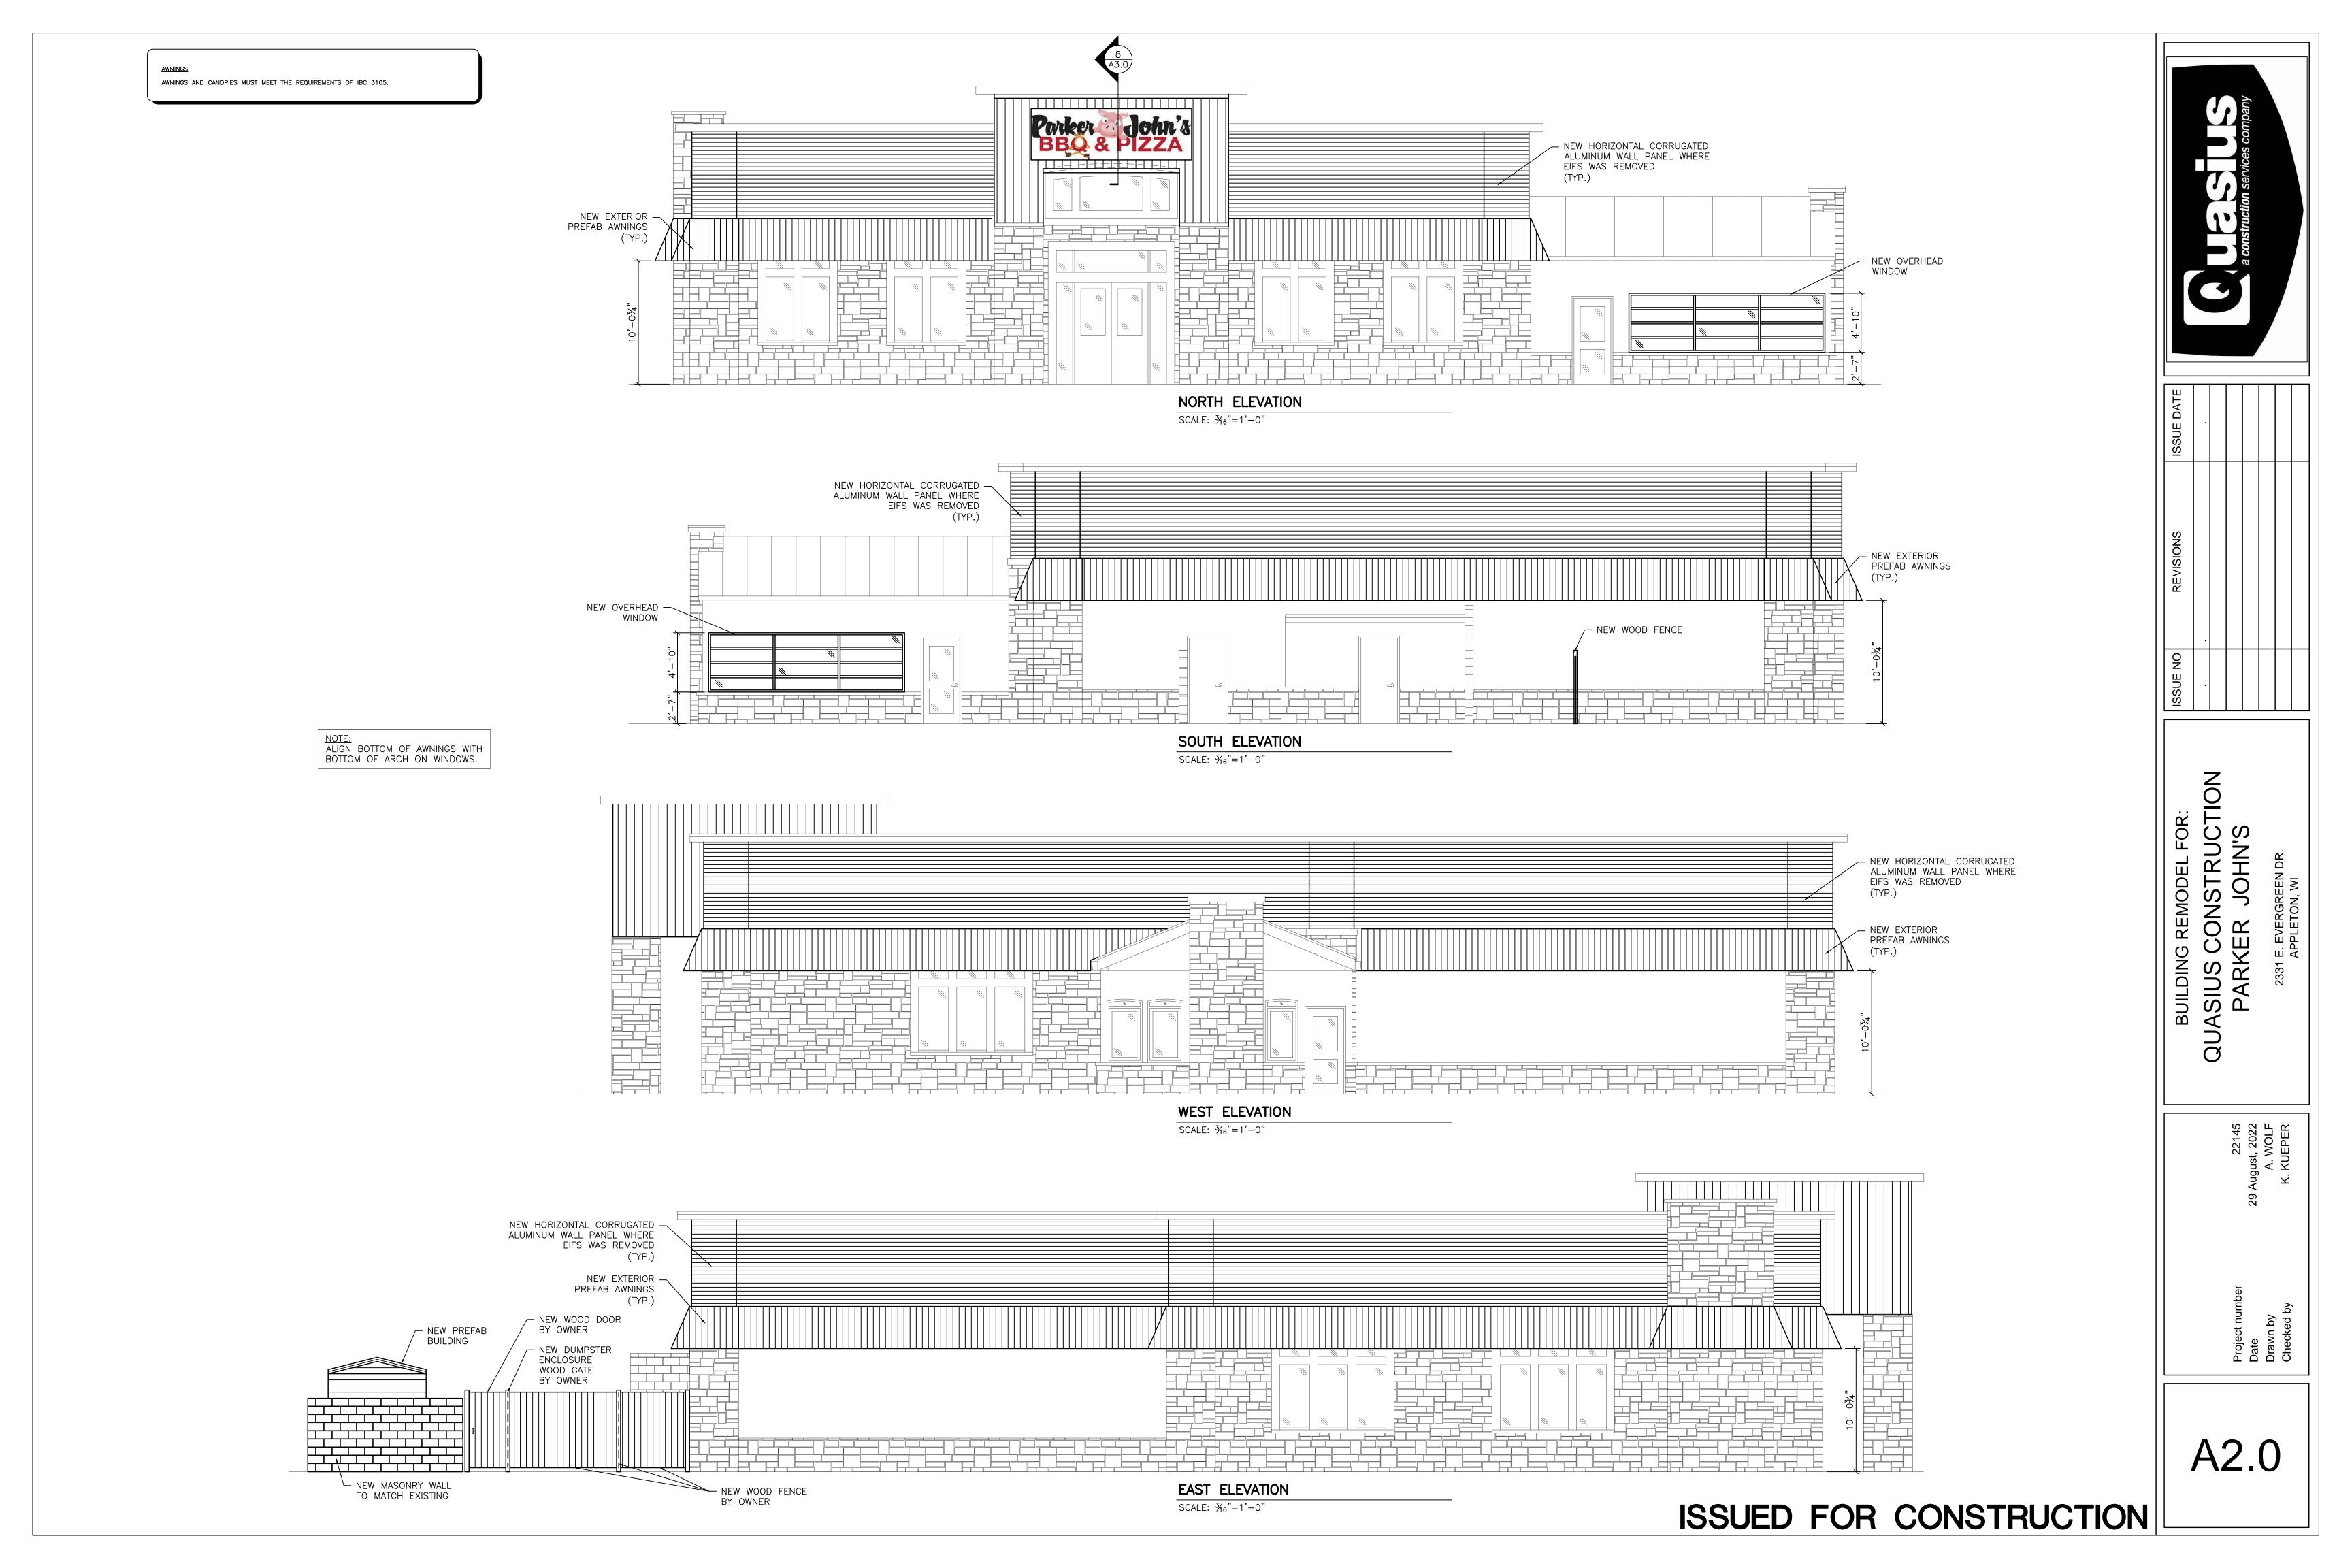

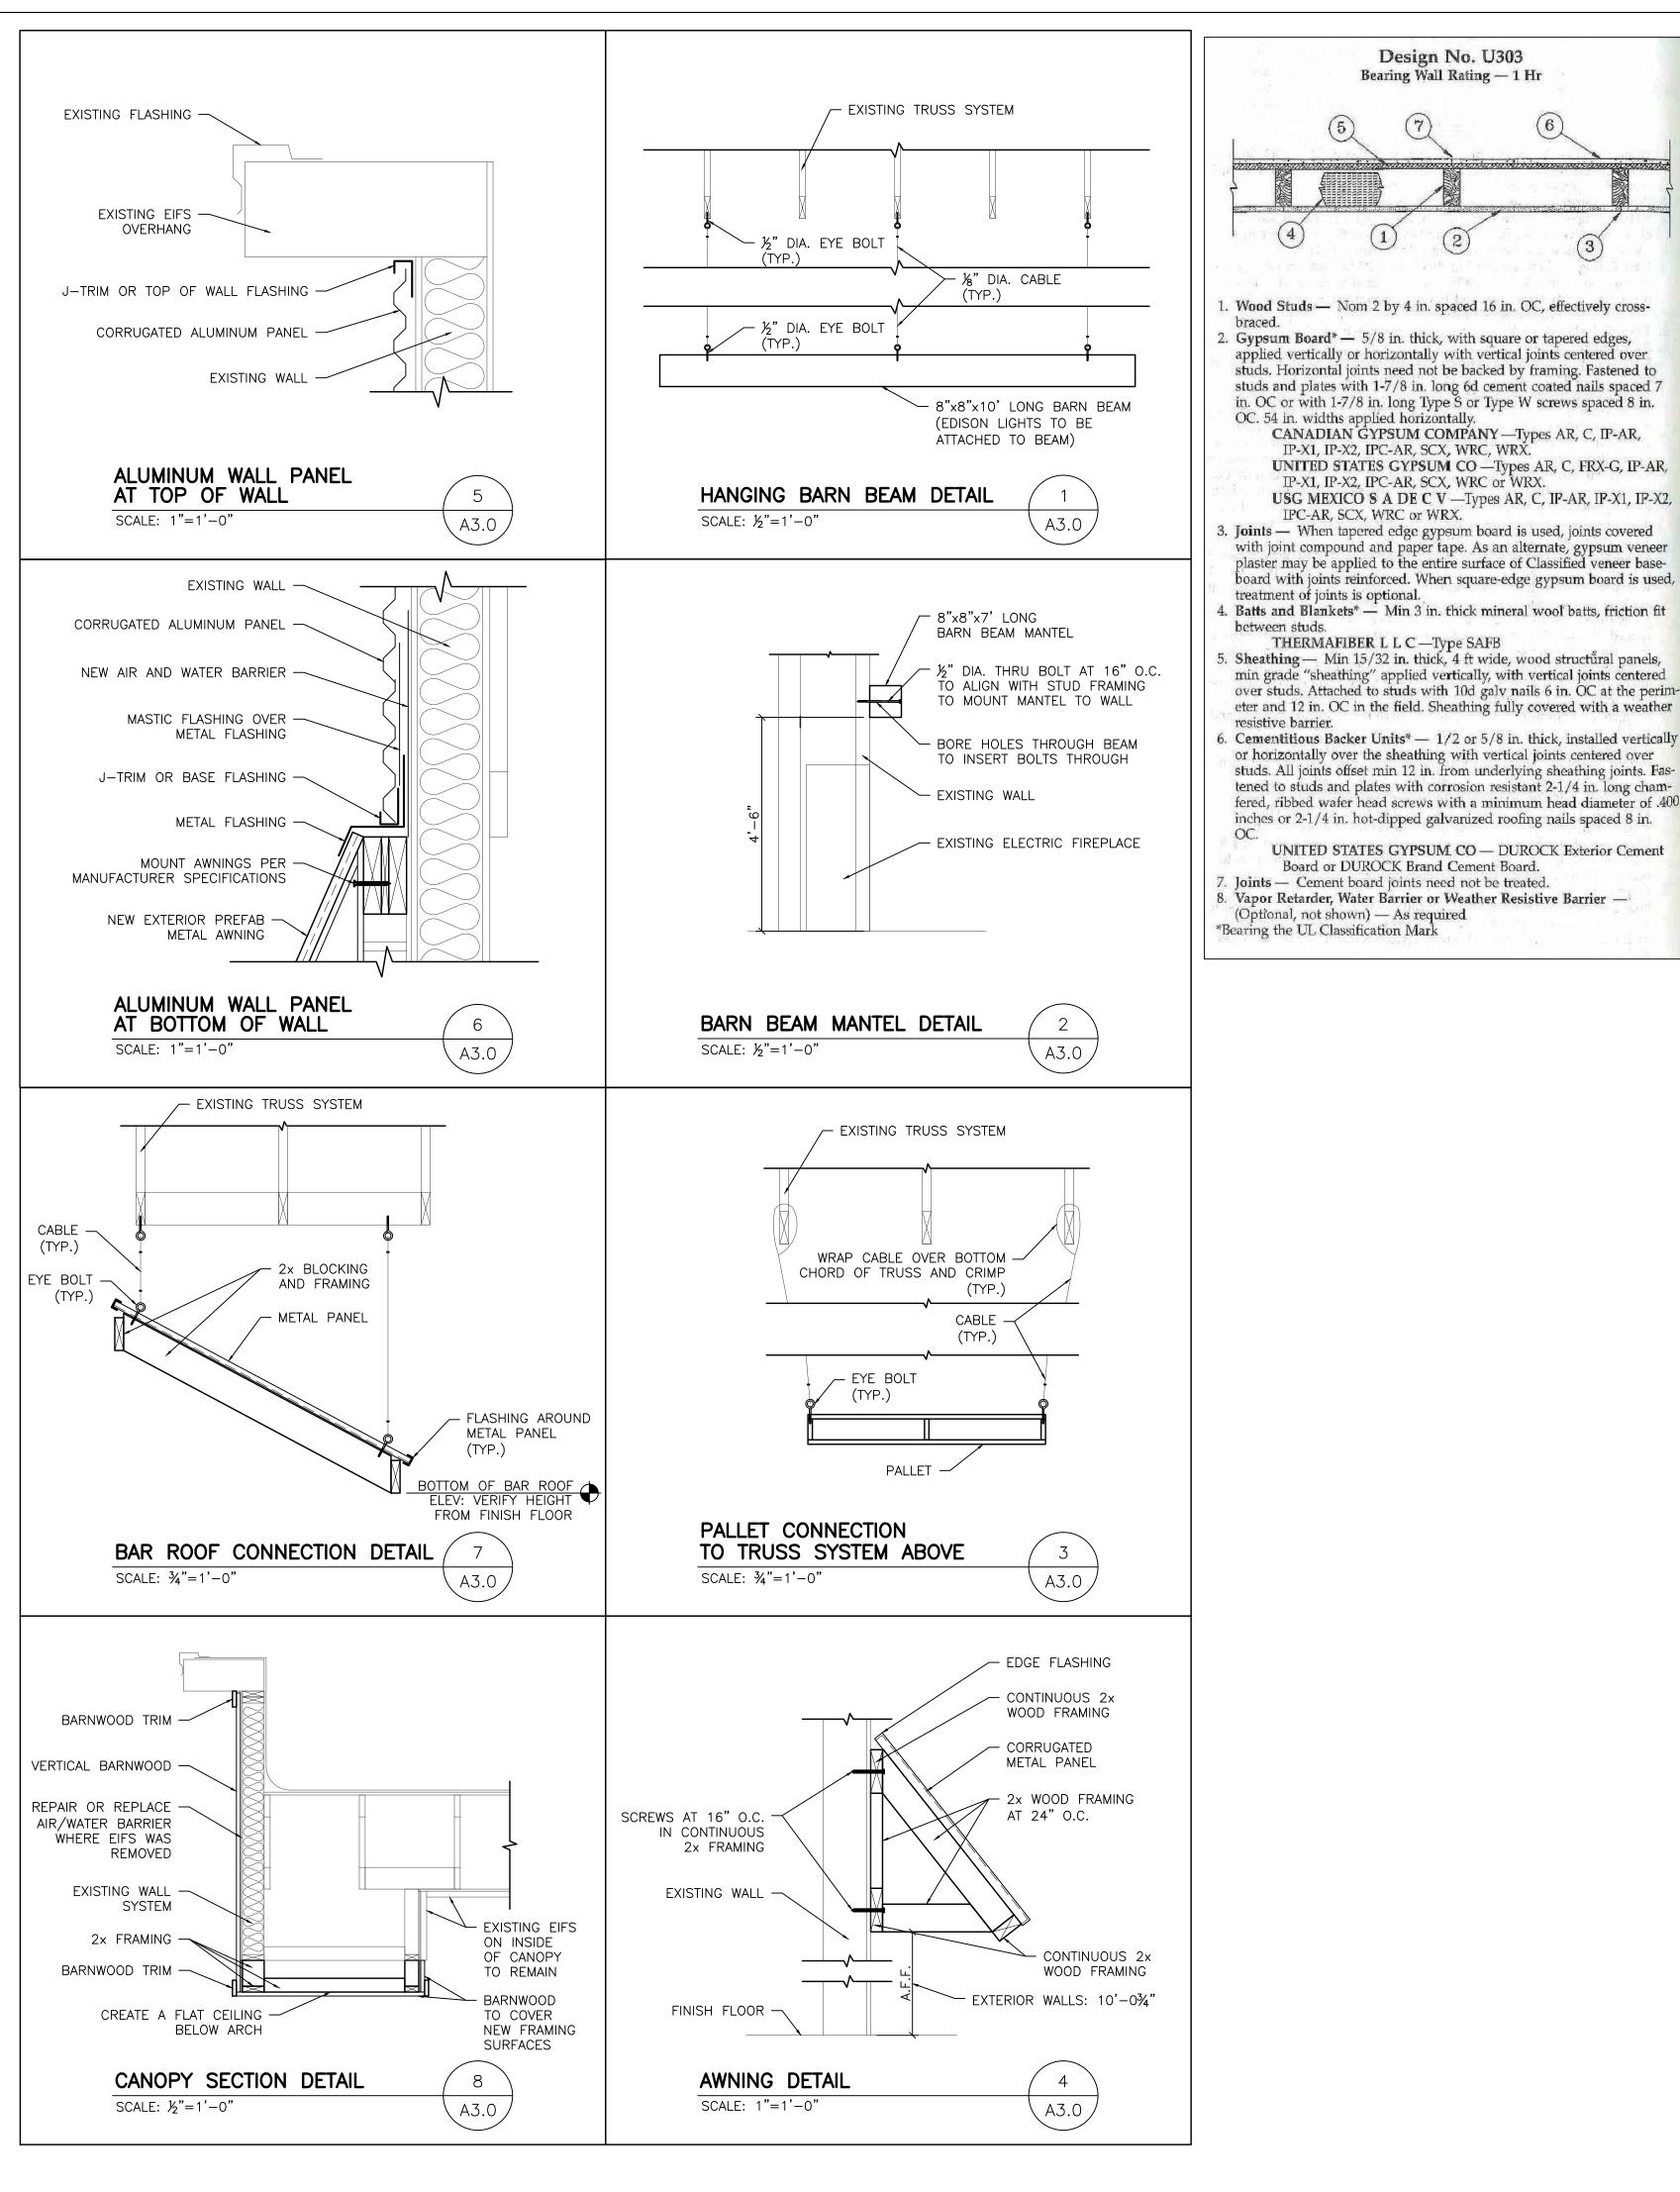

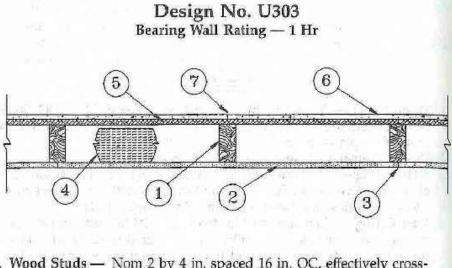

Wood Studs - Nom 2 by 4 in. spaced 16 in. OC, effectively cross-

. Gypsum Board* — 5/8 in. thick, with square or tapered edges, applied vertically or horizontally with vertical joints centered over studs. Horizontal joints need not be backed by framing. Fastened to studs and plates with 1-7/8 in. long 6d cement coated nails spaced 7 in. OC or with 1-7/8 in. long Type S or Type W screws spaced 8 in. OC. 54 in. widths applied horizontally.

CANADIAN GYPSUM COMPANY — Types AR, C, IP-AR, IP-X1, IP-X2, IPC-AR, SCX, WRC, WRX. UNITED STATES GYPSUM CO —Types AR, C, FRX-G, IP-AR, IP-X1, IP-X2, IPC-AR, SCX, WRC of WRX.

IPC-AR, SCX, WRC or WRX. . Joints — When tapered edge gypsum board is used, joints covered with joint compound and paper tape. As an alternate, gypsum veneer plaster may be applied to the entire surface of Classified veneer base-board with joints reinforced. When square-edge gypsum board is used,

4. Batts and Blankets* - Min 3 in. thick mineral wool batts, friction fit


THERMAFIBER L L C—Type SAFB

Sheathing — Min 15/32 in. thick, 4 ft wide, wood structural panels, min grade "sheathing" applied vertically, with vertical joints centered over studs. Attached to studs with 10d galv nails 6 in. OC at the perimeter and 12 in. OC in the field. Sheathing fully covered with a weather

. Cementitious Backer Units* — 1/2 or 5/8 in. thick, installed vertically or horizontally over the sheathing with vertical joints centered over studs. All joints offset min 12 in. from underlying sheathing joints. Fastened to stude and plates with corrosion resistant 2-1/4 in. long chamfered, ribbed wafer head screws with a minimum head diameter of .400 inches or 2-1/4 in. hot-dipped galvanized roofing nails spaced 8 in.

UNITED STATES GYPSUM CO — DUROCK Exterior Cement Board or DUROCK Brand Cement Board. Joints — Cement board joints need not be treated.

8. Vapor Retarder, Water Barrier or Weather Resistive Barrier -(Optional, not shown) — As required *Bearing the UL Classification Mark

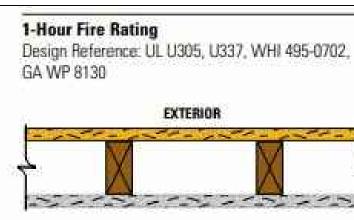

SCALE: ½"=1'-0"


30-34 STC Sound Trans. Test Reference: OR 64-8


Wall Thickness: 4-3/4" (121 mm)

Weight per Sq. Ft.: 7.5 psf (37 Kg/m²)

Exterior: 5/8" (15.9 mm) DensGlass® Fireguard® Sheathing applied vertically (U337, U305) or horizontally (U305) to 2" (51 mm) x 4" (102 mm) wood study 16" (406 mm) o.c. with 1-3/4" (45 mm) galvanized roofing nails 7" (178 mm) o.c. for all framing members. Exterior surface covered with weather exposed cladding or finish system.

Interior: 5/8" (15.9 mm) DensArmor Plus® Fireguard® interior panels or 5/8" (15.9 mm) ToughRock® Fineguard X® gypsum board applied vertically (U337, U305) or horizontally (U305) to stude with 1-7/8" (48 mm) 6d coated nails 7" (178 mm) o.c. Stagger joints each side.

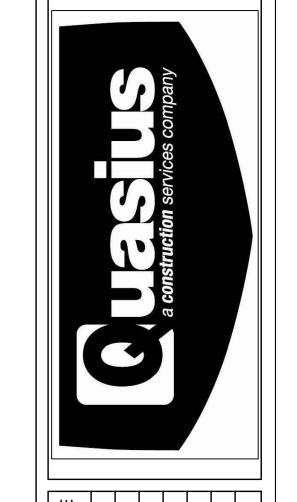

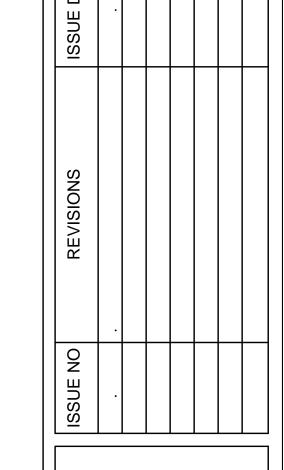


BUILDING REMODEL FOR:
JASIUS CONSTRUCT
PARKER JOHN'S

A3.0

ISSUED FOR CONSTRUCTION

WALL SECTION

SCALE: ½"=1'-0"

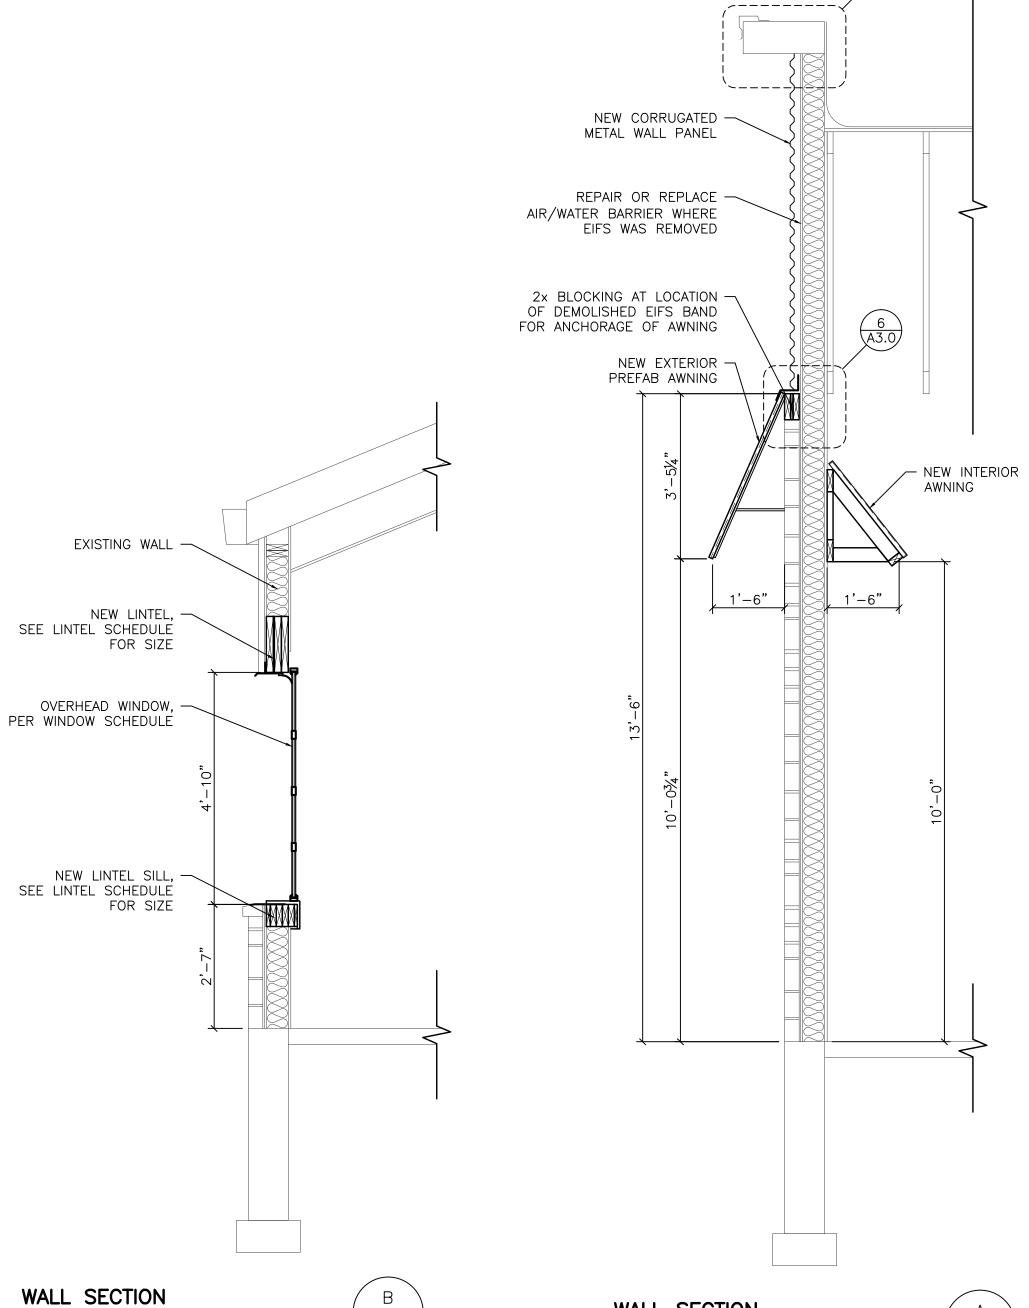

DOORS, WINDOWS AND FRAMES

FURNISH AND INSTALL ALL DOORS AND WINDOW ASSEMBLIES AS INDICATED ON THE PLANS. INCLUDE ALL HARDWARE INDICATED AND THAT MAY BE REQUIRED FOR A COMPLETE JOB. DOORS AND WINDOWS SHALL OPERATE SMOOTHLY WITHOUT BINDING AND BE INSTALLED PLUM AND TRUE. HARDWARE SHALL FIT PROPERLY AND BE ADJUSTED AS REQUIRED. PROVIDE INSECT SCREENS ON ALL OPERABLE WINDOW UNITS.

<u>HARDWARE</u>

UNLESS SPECIFIED IN THE HARDWARE SCHEDULE:

-ALL LOCK SETS SHALL BE LEVER TYPE AS REQUIRED TO MEET REQUIREMENTS OF THE A.D.A.

-ALL OTHER HARDWARE SHALL CONFORM TO THE REQUIREMENTS OF THE A.D.A.

-ALL EXIT DOORS SHALL BE EQUIPPED WITH LEVER TYPE EXIT HARDWARE OPENABLE FROM THE INSIDE WITHOUT THE USE OF A LATCH, KEY, OR BOLT.

FINISHES

PROVIDE AND INSTALL ALL FINISHES AS INDICATED ON PLANS. INSTALL ALL MATERIALS PER MANUFACTURER'S RECOMMENDATIONS AND SPECIFICATIONS. "FINISH" INSTALLER INSPECT SUBSURFACE AND PREPARE AS REQUIRED PRIOR TO INSTALLATION OF THE PRODUCT.

INTERIOR FINISHES TO MEET THE REQUIREMENTS OF IBC CHAPTER 8.

PAINT ALL AREAS REQUIRED FOR A COMPLETE JOB.

APPLY PAINT AS RECOMMENDED BY STANDARD PRACTICE AND MANUFACTURER'S

REMOVE OR PROTECT HARDWARE, PLATES, LIGHT FIXTURES, SPRINKLER HEADS, ETC. THAT ARE NOT INTENDED TO BE PAINTED. PROVIDE MASKING AS REQUIRED.

DISPOSAL OF EXCESS PAINT MATERIALS IS THE RESPONSIBILITY OF THE PAINTING CONTRACTOR. DISPOSAL MUST BE IN ACCORDANCE WITH APPLICABLE LAWS AND CODES.

<u>SEALANTS</u>

PROVIDE CAULKING AND BACKER ROD AS RECOMMENDED BY THE MANUFACTURER TO SEAL EXTERIOR AND INTERIOR JOINTS, AT EXPANSION JOINTS, FRAMES OF DOORS, WINDOWS, AND OTHER EXTERIOR OPENINGS. ALSO CAULK AROUND PLUMBING FIXTURES, COUNTERTOPS, ROOF OPENINGS, ETC. AND AS REQUIRED FOR A COMPLETE JOB. CAULK TO BE INSTALLED AFTER FINISH IS APPLIED TO SURFACES. PENETRATIONS THROUGH FIRE RATED ASSEMBLIES MUST MEET U.L. REQUIREMENTS.


SIGNAGE

SIGNAGE SHALL MEET THE REQUIREMENTS OF THE A.D.A.

WHERE PERMANENT IDENTIFICATION IS PROVIDED FOR ROOMS AND SPACES, SIGNS SHALL BE INSTALLED ON THE WALL ADJACENT TO THE LATCH SIDE OF THE DOOR, WHERE THERE IS NO WALL SPACE TO THE LATCH SIDE OF THE DOOR, INCLUDING AT DOUBLE—LEAF DOORS, SIGNS SHALL BE PLACED ON THE NEAREST ADJACENT WALL.

MOUNTING HEIGHT SHALL BE 60" ABOVE FINISH FLOOR TO THE CENTERLINE OF THE SIGN UNLESS INDICATED OTHERWISE.


PROVIDE HANDICAP PARKING SIGNS AS INDICATED ON THE PLANS AND AS REQUIRED BY APPLICABLE LAWS.

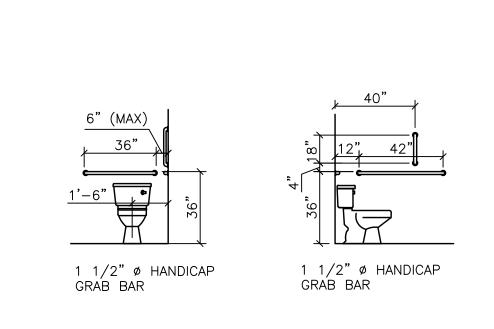



NOTE: STANDARDS SHOWN ARE PER ANSI A117.1


TYP. TOILET ROOM ACCESSORIES

SCALE: 1/4"=1'-0"

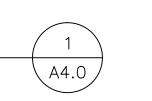


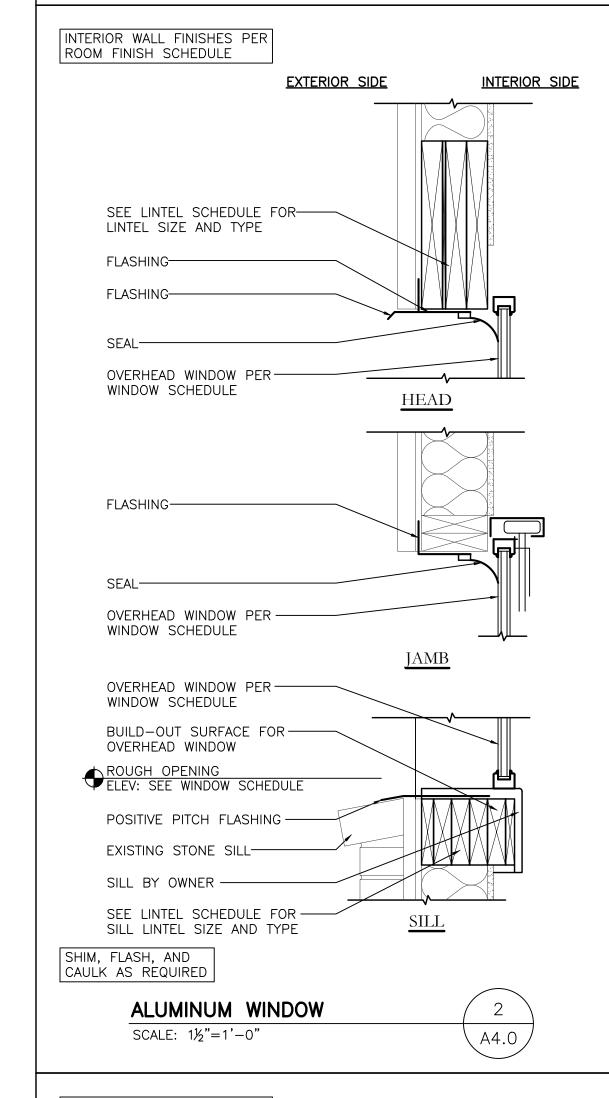


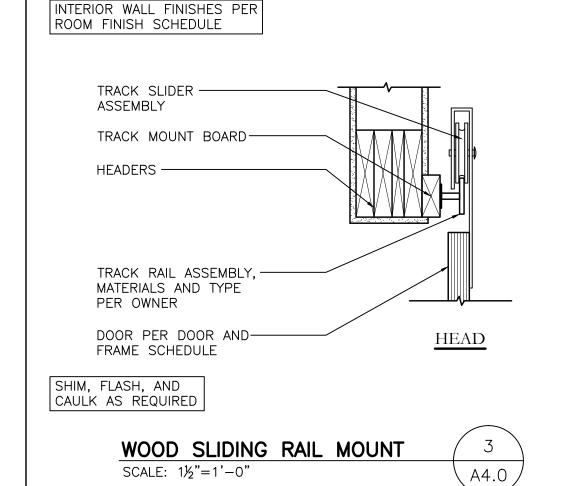


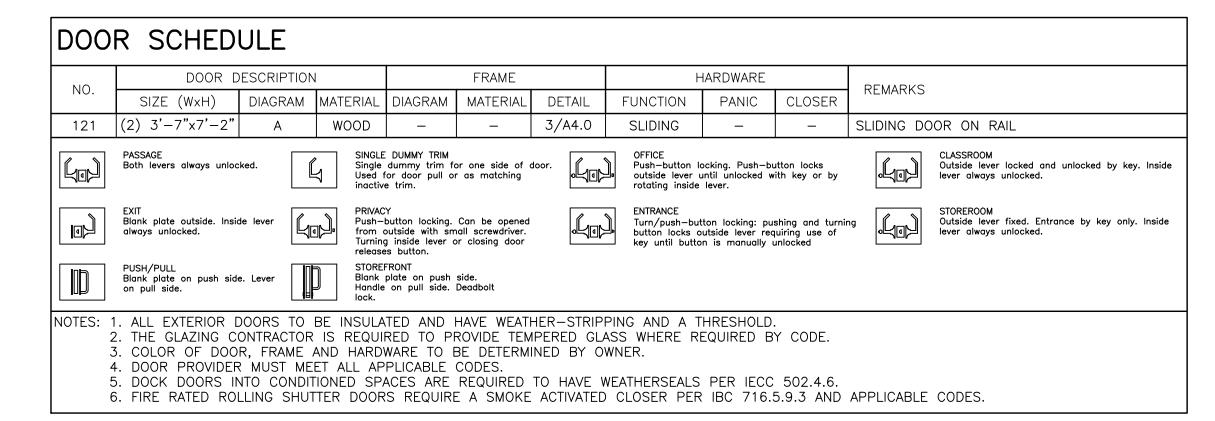

WINDOW SCHEDULE												
NO.	QTY.	WINDOW		FRAME		GLAZING			REMARKS			
		SIZE (WxH)	HEAD HEIGHT	MATERIAL	DIAGRAM	DETAIL	THICKNESS	TINT	LOW-E	KLIMAKKS		
Α	2	16'-0" x 4'-10"	4'-10"	ALUM.	AA	2/A4.0	1"	_	_	_		
NOTES:	NOTES: 1. THE GLAZING CONTRACTOR IS REQUIRED TO PROVIDE TEMPERED GLASS WHERE REQUIRED BY CODE. 2. THE GLAZING CONTRACTOR SHALL PROVIDE ALL FLASHING AND CAULK AS REQUIRED FOR A COMPLETE JOB. 3. THE COLOR OF THE FRAME IS TO BE DETERMINED BY THE OWNER.											

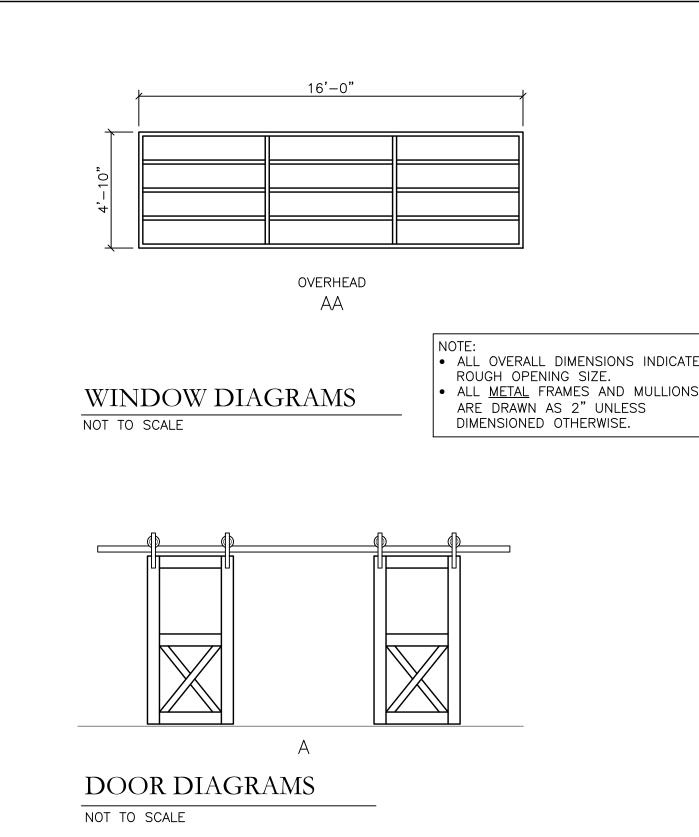

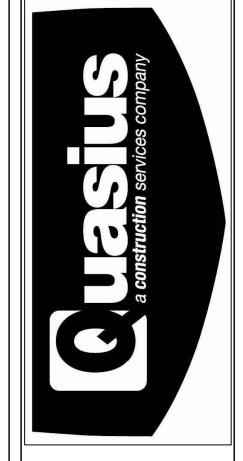

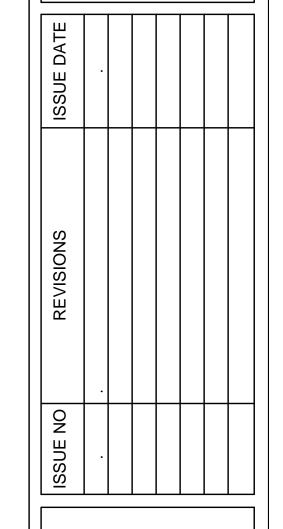

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